



Custom Home Designs

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PLAN # 2012

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PROJECT DETAILS

WINDOWS:	ANDERSEN 400 SERIES
FOUNDATION:	10" CONC. WALL
EXTERIOR WALLS:	2x6
GARAGE WALLS:	2x4
INTERIOR WALLS:	2x4
FIRST FLOOR:	10'-1 1/8"
SECOND FLOOR:	9'-1 1/8"
BASEMENT:	10'-0"

CUSTOM HOME DESIGNS, LLC

2841 S. 150 E.
COLUMBIA CITY, IN 46725
(260) 244-5851
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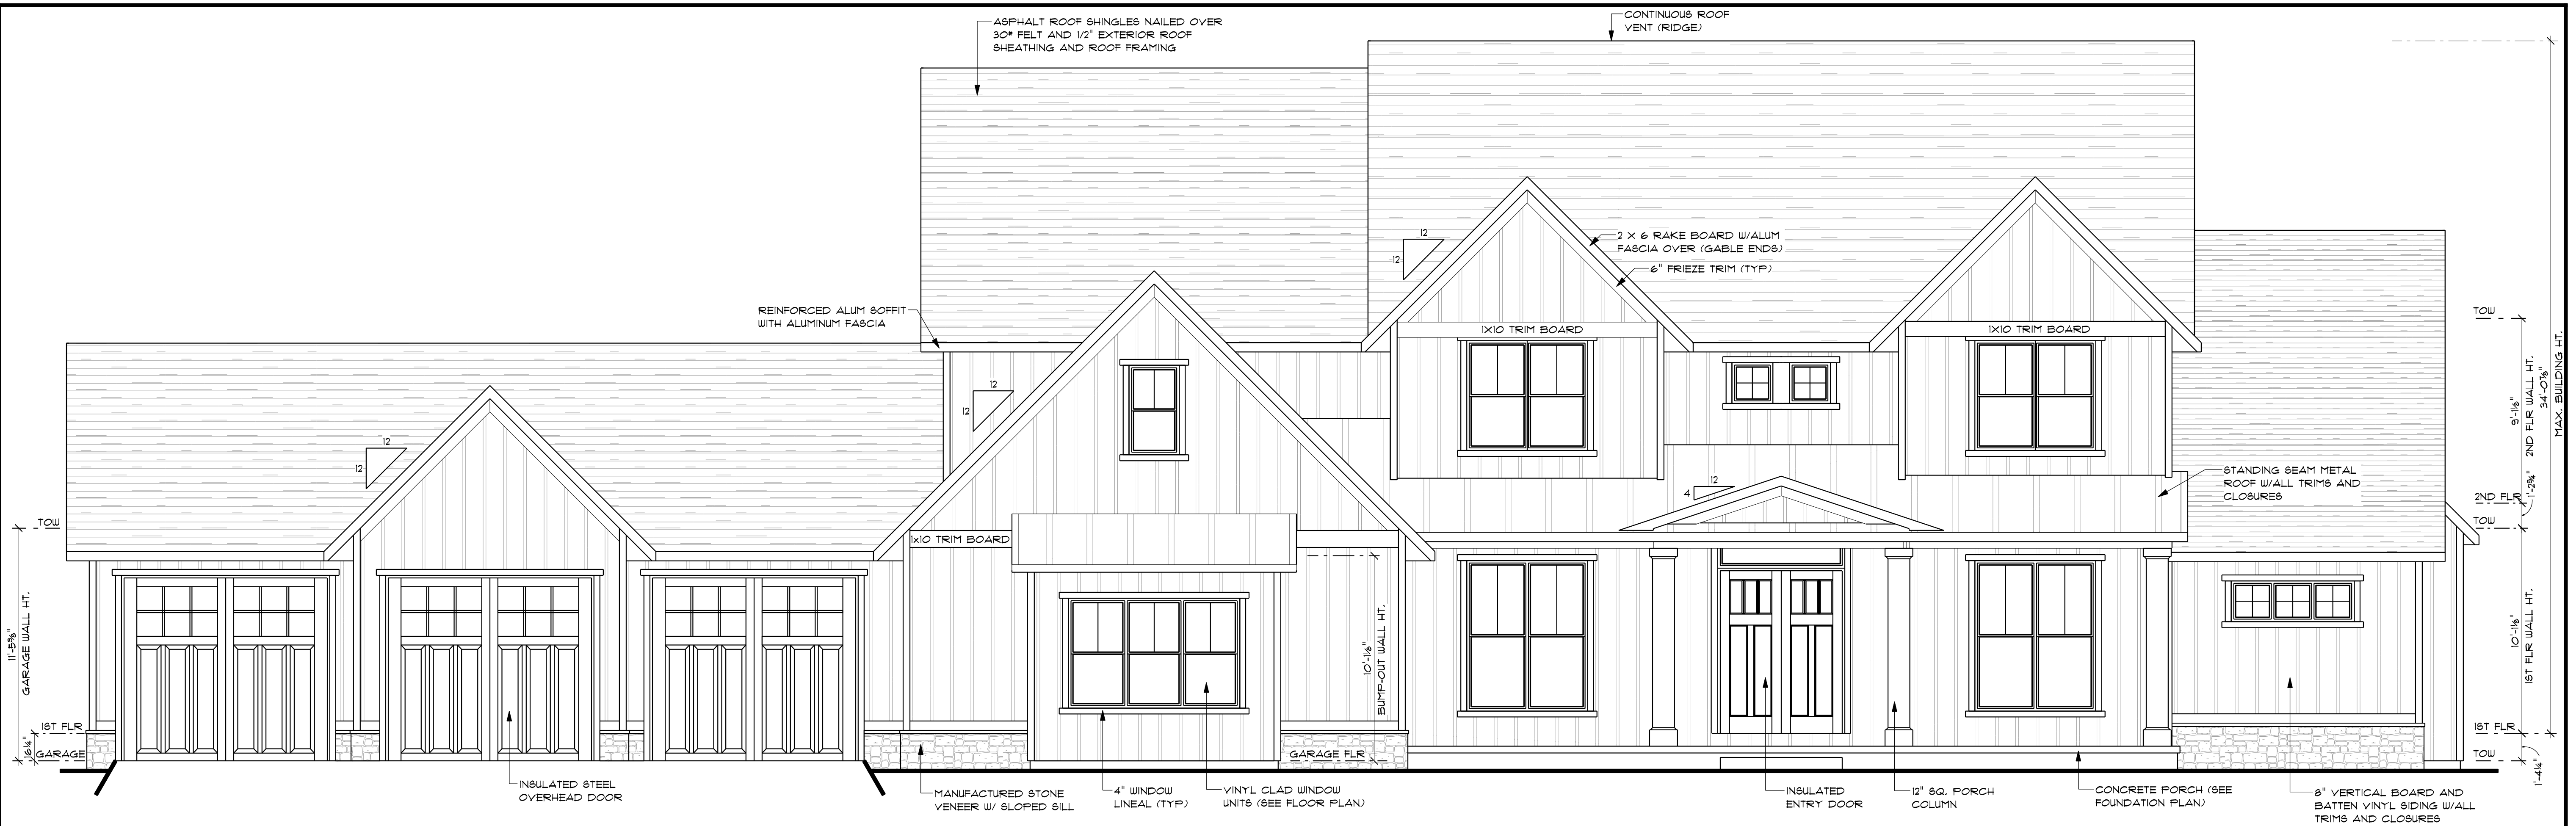
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ELEVATIONS


PLAN #2012

DRAWN BY: BG
PROJECT: 2012
PRINT DATE:
10/18/2021
FINAL: MAR. 20, 2020
SCALE: 1/4" = 1'-0"

A-1



FRONT ELEVATION
SCALE: 1/4" = 1'-0"

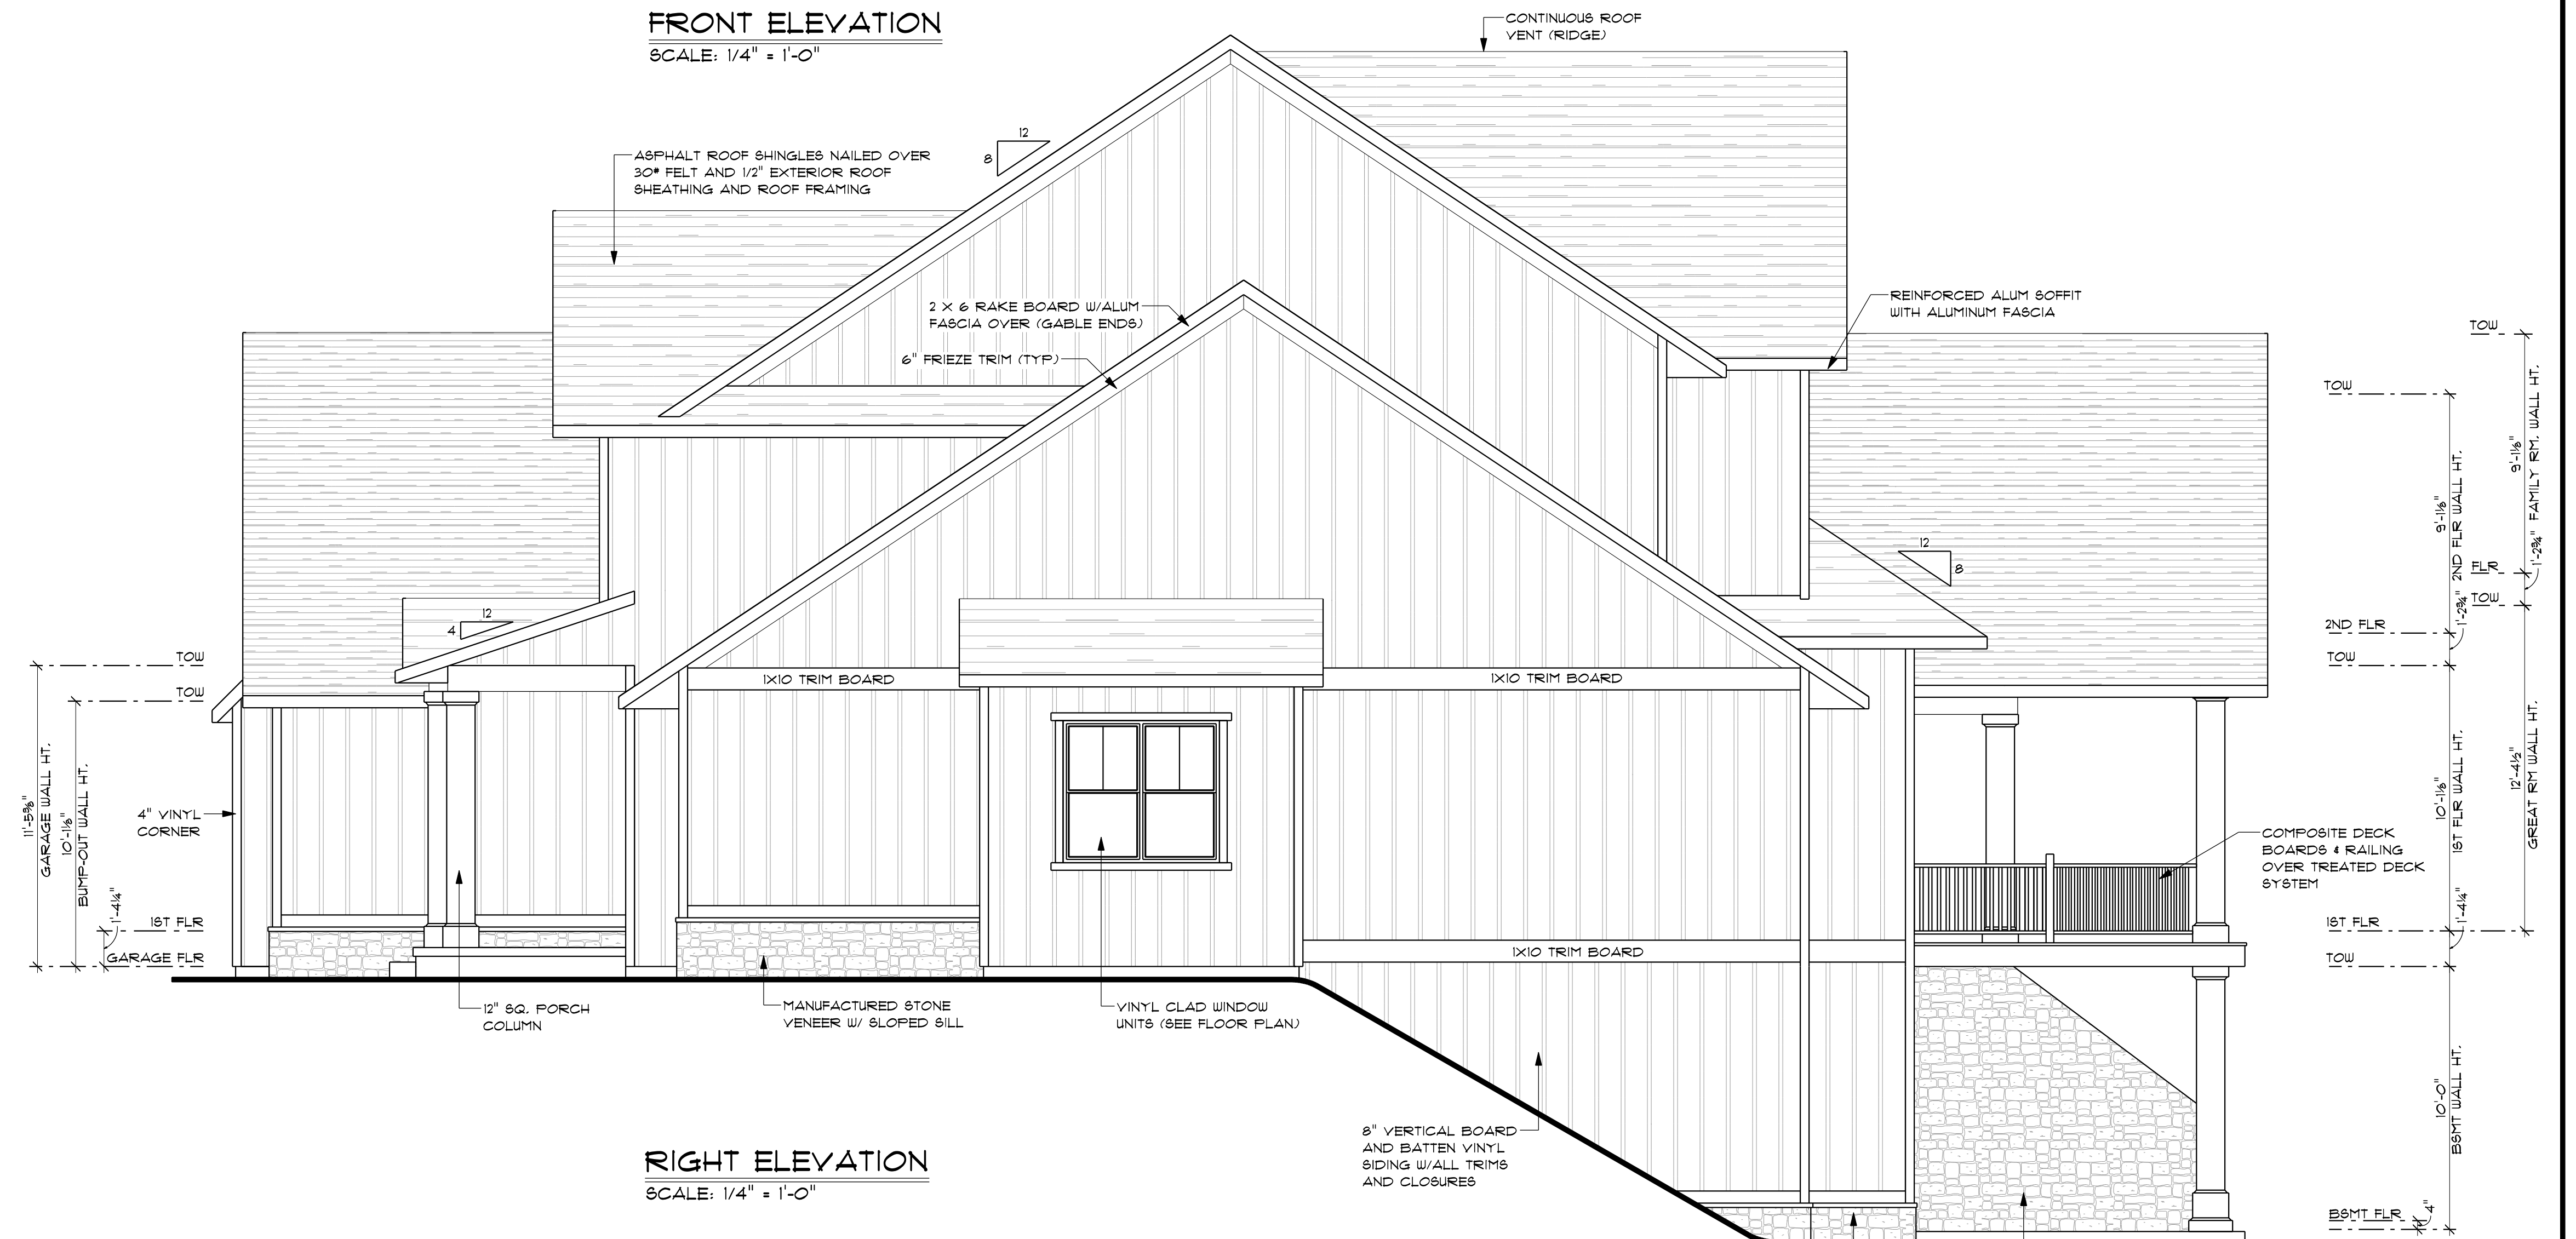

RIGHT ELEVATION
SCALE: 1/4" = 1'-0"

PROJECT DETAILS

WINDOWS:	ANDERSEN 400 SERIES
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ELEVATIONS
PLAN #2012

DRAWN BY: BG
 PROJECT: 2012
 PRINT DATE:
 10/18/2021
 FINAL: MAR. 20, 2020
 SCALE: 1/4" = 1'-0"



REAR ELEVATION
 SCALE: 1/4" = 1'-0"

- GENERAL NOTES:**
1. ALL DIMENSIONS TO FACE OF STUD WALL.
 2. ALL ANGLED WALLS ASSUMED TO BE 45 DEGREES UNLESS OTHERWISE INDICATED.
 3. ALL WOOD FRAMING IN DIRECT CONTACT WITH CONCRETE OR MASONRY TO BE TREATED.
 4. ALL EXTERIOR WALLS TO BE 2x6 (5 1/2") UNLESS NOTED OTHERWISE. ALL INTERIOR WALLS TO BE 2x4 (3 1/2") UNLESS NOTED OTHERWISE. GARAGE WALLS TO BE 2x4 (3 1/2").
 5. ALL CONSTRUCTION TO BE AS REQUIRED BY THE INDIANA RESIDENTIAL CODE (IRC) THAT IS CURRENTLY IN EFFECT IN INDIANA.
 6. THESE PLANS ARE INTENDED TO SHOW GENERAL DESIGN ONLY. THE FINAL LAYOUT AND DETAIL OF THESE DRAWINGS ARE THE RESPONSIBILITY OF CONTRACTOR AND/OR HOMEOWNERS AND SHOULD BE VERIFIED TO BE CORRECT PRIOR TO CONSTRUCTION. ANY DISCREPANCIES OR ERRORS FOUND IN THE PLANS TO BE REPORTED TO THE DESIGNER AND APPROPRIATE PLANS TO BE RE-ISSUED IF NECESSARY.
 7. ALL GRADE LINES SHOWN ARE ESTIMATES OF THE FINAL GRADE AND ARE SCHEMATIC ONLY.
 8. STAIR RISE & RUN CALCULATIONS ARE SHOWN FOR REFERENCE ONLY. VERIFY ALL FLOOR TO FLOOR MEASUREMENTS BEFORE COMMENCEMENT OF STAIRWAY FRAMING.
 9. VERIFY SIZE AND ALL ROUGH OPENINGS REQUIRED FOR THE FIREPLACE IF REQUIRED BEFORE FRAMING.
 10. ALL ROOM DIMENSIONS SHOWN DURING THE PRELIMINARY PLAN PHASE ARE TO BE CONSIDERED ROUGH DIMENSIONS AND NOT A REFLECTION OF THE FINAL ROOM SIZES.
 11. WINDOW HEAD HEIGHTS SHOULD BE CHANGED IF REQUIRED FOR PROPER ROOF CLEARANCE.
 12. NOT ALL FRAMING BEAMS HAVE BEEN LOCATED OR VERIFIED. LOCATION AND SIZING OF THOSE BEAMS TO BE PERFORMED BY A QUALIFIED INDIVIDUAL PRIOR TO CONSTRUCTION. CONTRACTOR TO VERIFY LOCATIONS OF ALL BEARING POINTS AND THICKEN ALL FLOOR SLABS AND OR FOUNDATIONS AS REQUIRED TO MEET BEARING REQUIREMENTS.
 13. CONTRACTOR TO IDENTIFY ALL LOAD BEARING WALLS AND THICKEN BASEMENT SLABS APPROPRIATELY.
 14. PROPER FROST PROTECTION TO BE MAINTAINED, ADJUST ALL WALLS AND OR FOOTINGS TO MAINTAIN FROST PROTECTION.



LEFT ELEVATION
 SCALE: 1/4" = 1'-0"

PROJECT DETAILS


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BASEMENT:	10'-0"

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**FIRST FLOOR PLAN
 PLAN #2012**

DRAWN BY: BG
 PROJECT: 2012
 PRINT DATE:
 10/18/2021
 FINAL: MAR. 20, 2020
 SCALE: 1/4" = 1'-0"



AREA SCHEDULE	
NAME	AREA
FIRST FLOOR	2111 sq. Ft.
SECOND FLOOR	2425 sq. Ft.
BASEMENT	2138 sq. Ft.
GARAGE	1934 sq. Ft.
FRONT PORCH	350 sq. Ft.
COVERED PATIO	460 sq. Ft.
COVERED PORCH	613 sq. Ft.

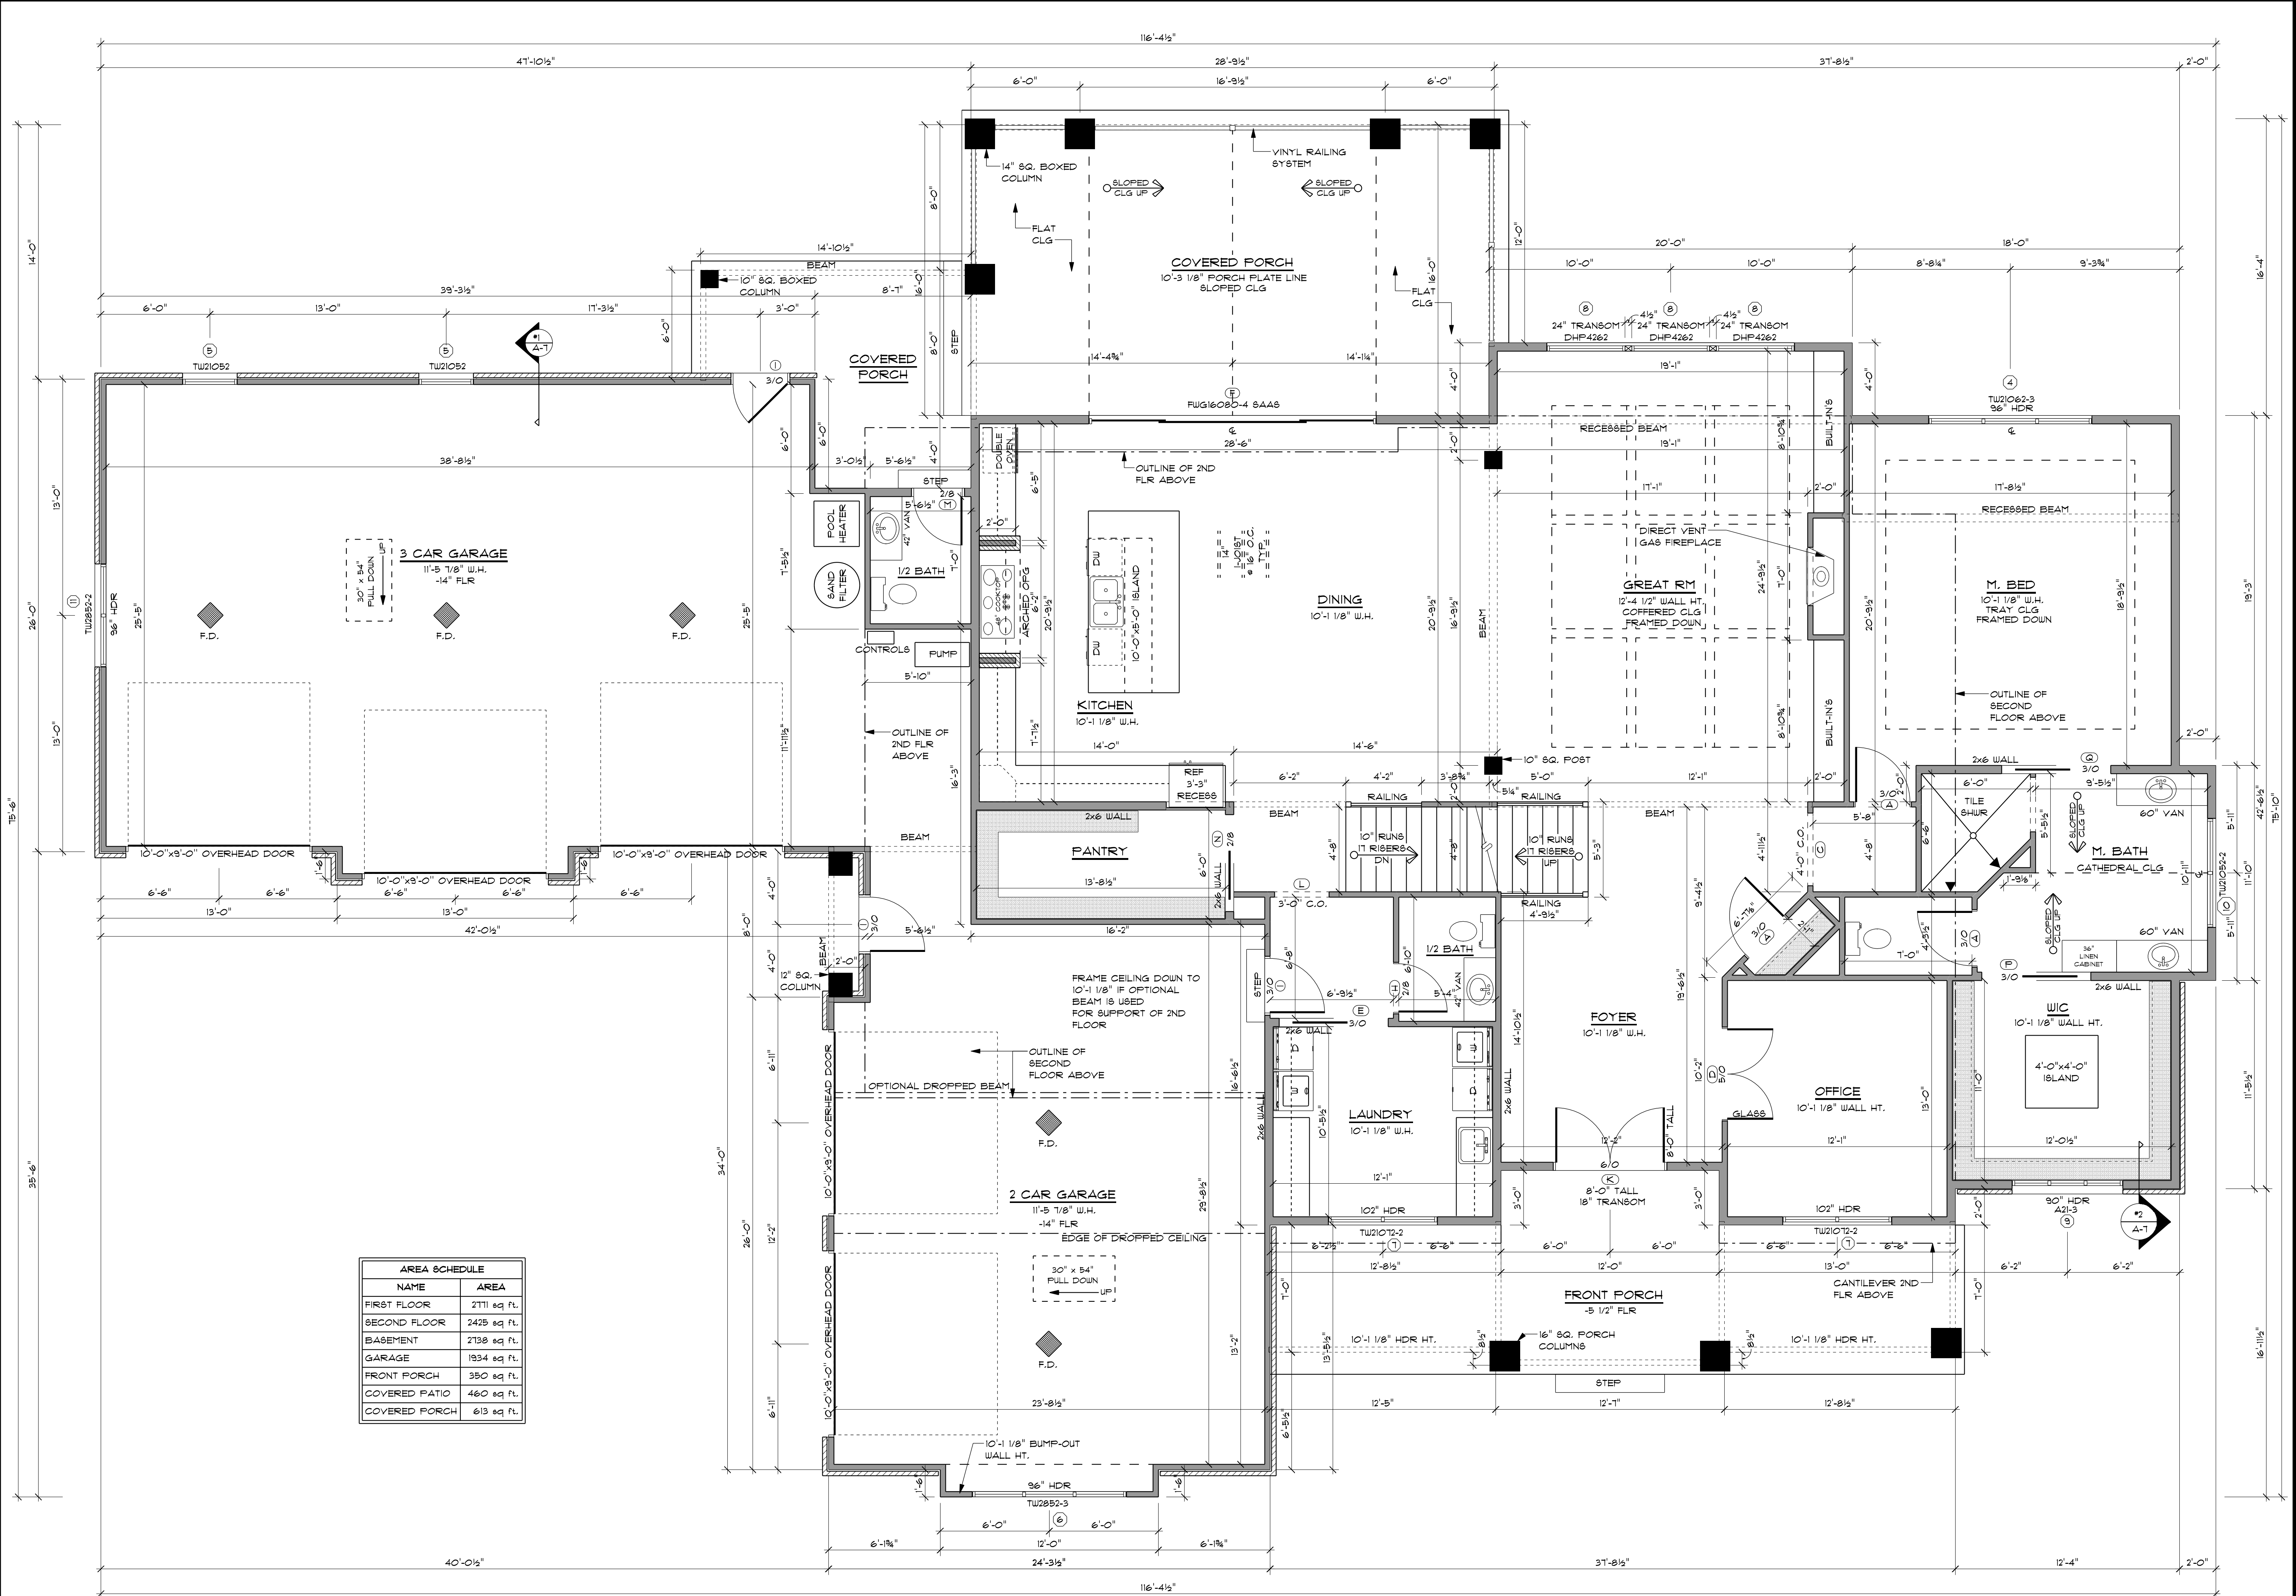FIRST FLOOR PLAN
 SCALE: 1/4" = 1'-0"

PROJECT DETAILS


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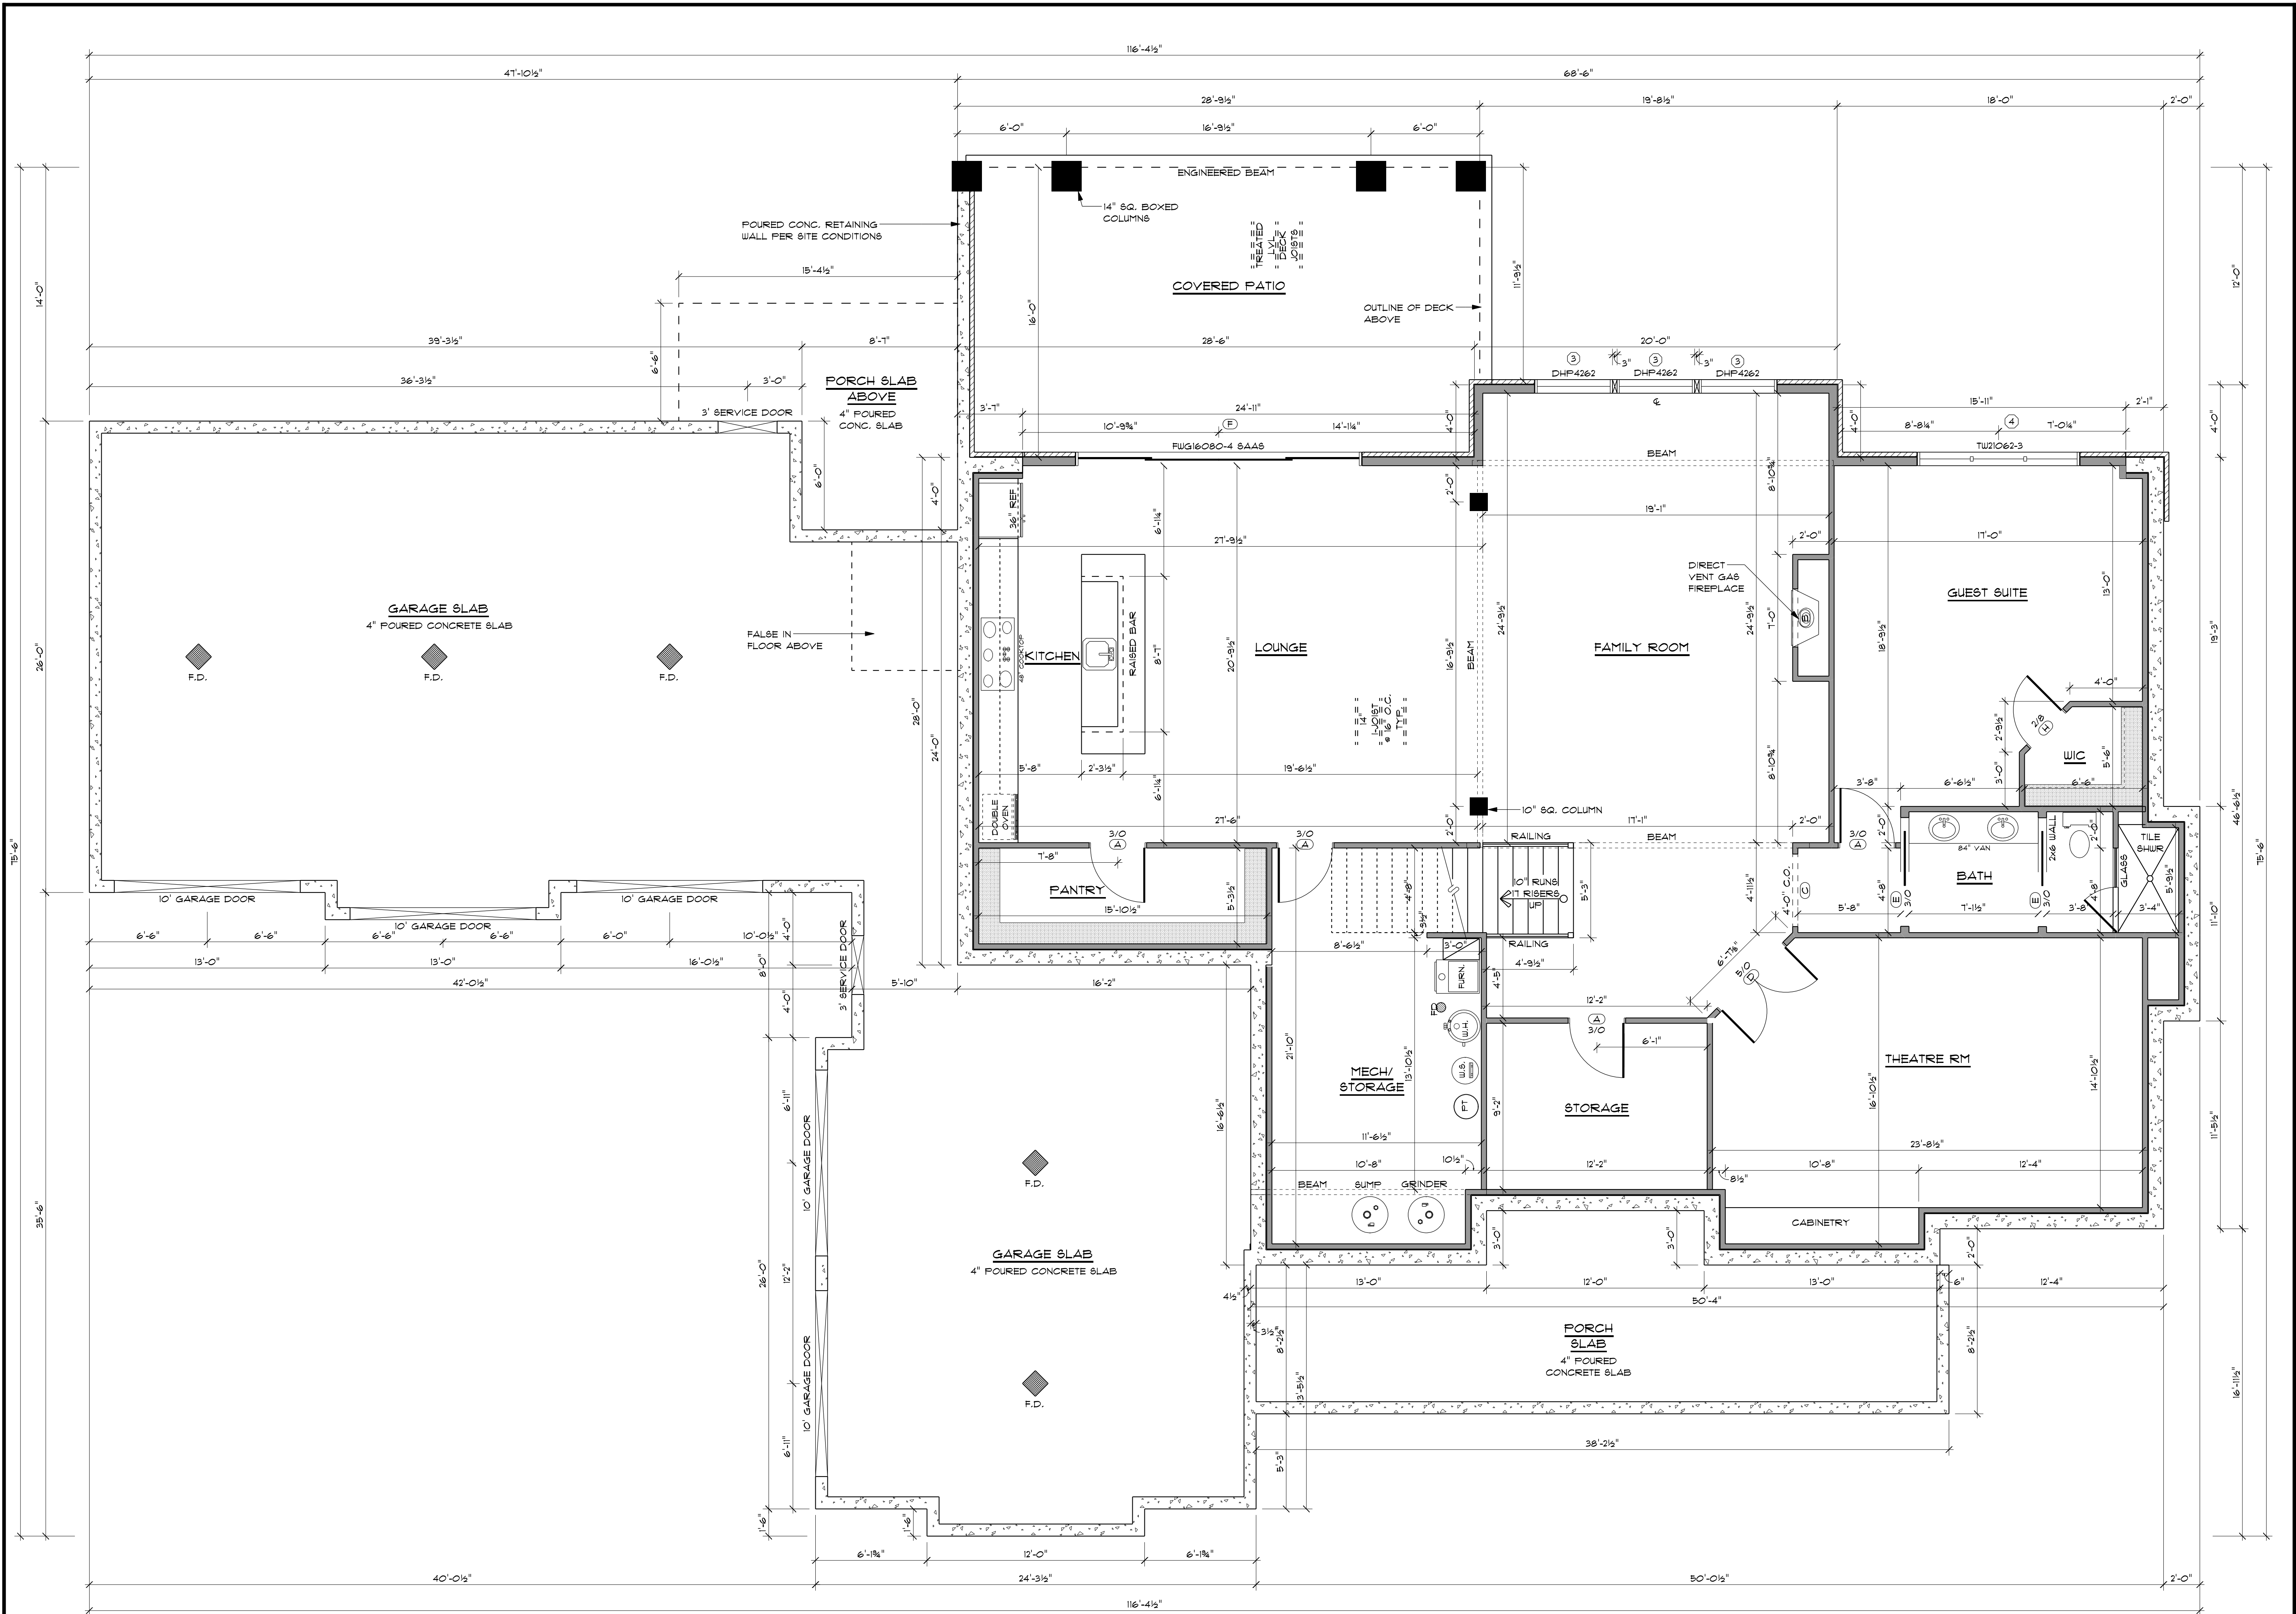
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SECOND FLOOR PLAN
PLAN #2012

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 PRINT DATE:
 10/18/2021
 FINAL: MAR. 20, 2020
 SCALE: 1/4" = 1'-0"



SECOND FLOOR PLAN
 SCALE: 1/4" = 1'-0"

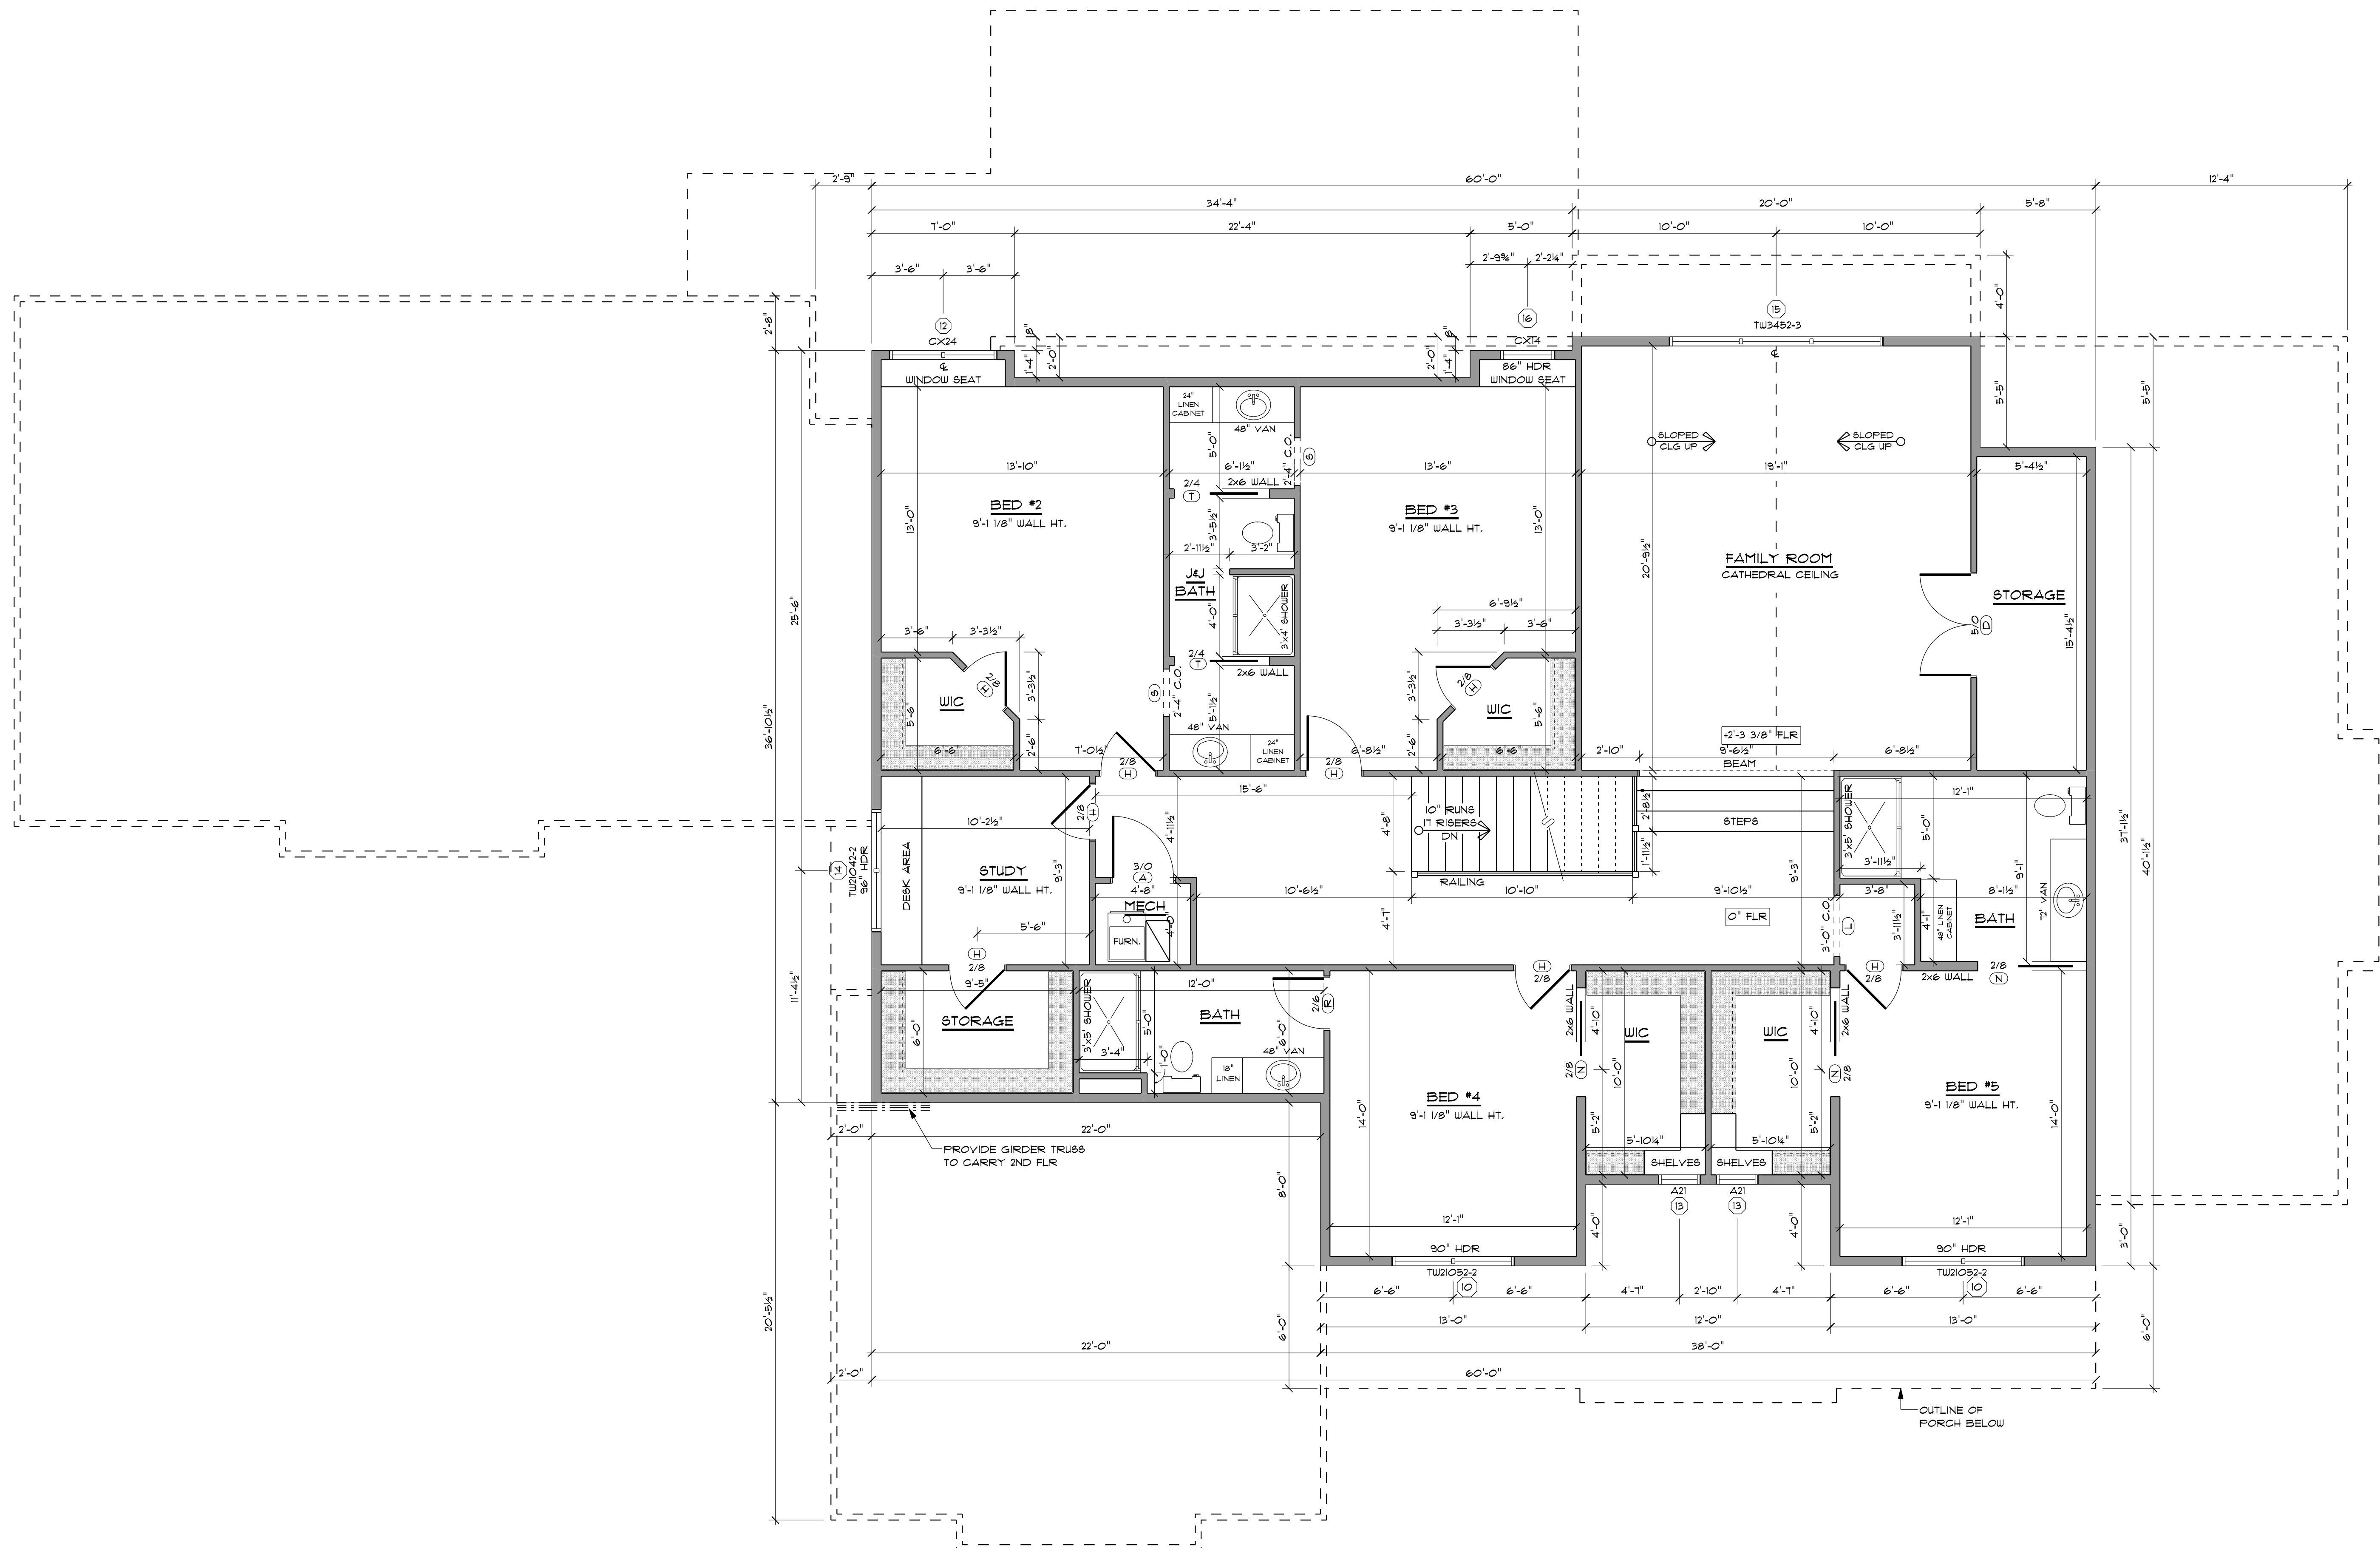

BASEMENT FLOOR PLAN
SCALE: 1/4" = 1'-0"

PROJECT DETAILS	
WINDOWS:	ANDERSEN 400 SERIES
FOUNDATION:	10" CONC. WALL
EXTERIOR WALLS:	2x6
GARAGE WALLS:	2x4
INTERIOR WALLS:	2x4
FIRST FLOOR:	10'-1 1/8"
SECOND FLOOR:	9'-1 1/8"
BASEMENT:	10'-0"


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BASEMENT PLAN
PLAN #2012

DRAWN BY:	BG
PROJECT:	2012
PRINT DATE:	10/18/2021
FINAL:	MAR. 20, 2020
SCALE:	1/4" = 1'-0"

A-5



**NOTE: FINAL CONCRETE FOOTING & WALL SIZES SUBJECT TO CHANGE ACCORDING TO SOILS INVESTIGATION REPORT. ALL FOOTINGS SIZES TO BE VERIFIED BY CONTRACTOR TO HAVE ADEQUATE SOIL BEARING.
 **NOTE: FROST DEPTH TO BE CONFIRMED BY CONTRACTOR. ALL FOOTINGS TO MEET ALL FROST DEPTHS AS REQUIRED BY ALL LOCAL AND STATE CODES.
 **FINAL CONCRETE WALL HEIGHTS TO BE DETERMINED BY CONTRACTOR UPON COMPLETION OF EXCAVATION.
 **BEAM POCKET SIZES AND LOCATIONS TO BE DETERMINED BY CONTRACTOR BEFORE POURING OF CONCRETE WALLS.
 **ALL DIMENSIONS TO OUTSIDE OF CONCRETE WALLS.
 **THICKEN ALL FLOOR SLABS UNDER BASEMENT WALLS WHERE REQUIRED FOR FLOOR JOIST BEARING, CONTRACTOR TO DETERMINE LOCATION ON SITE.
 **WHERE BASEMENT WALLS ARE DRAIN WITH A BRICK LEDGE, ALL DIMENSIONS ARE TO THE OUTSIDE EDGE OF THE STUD FRAMING.

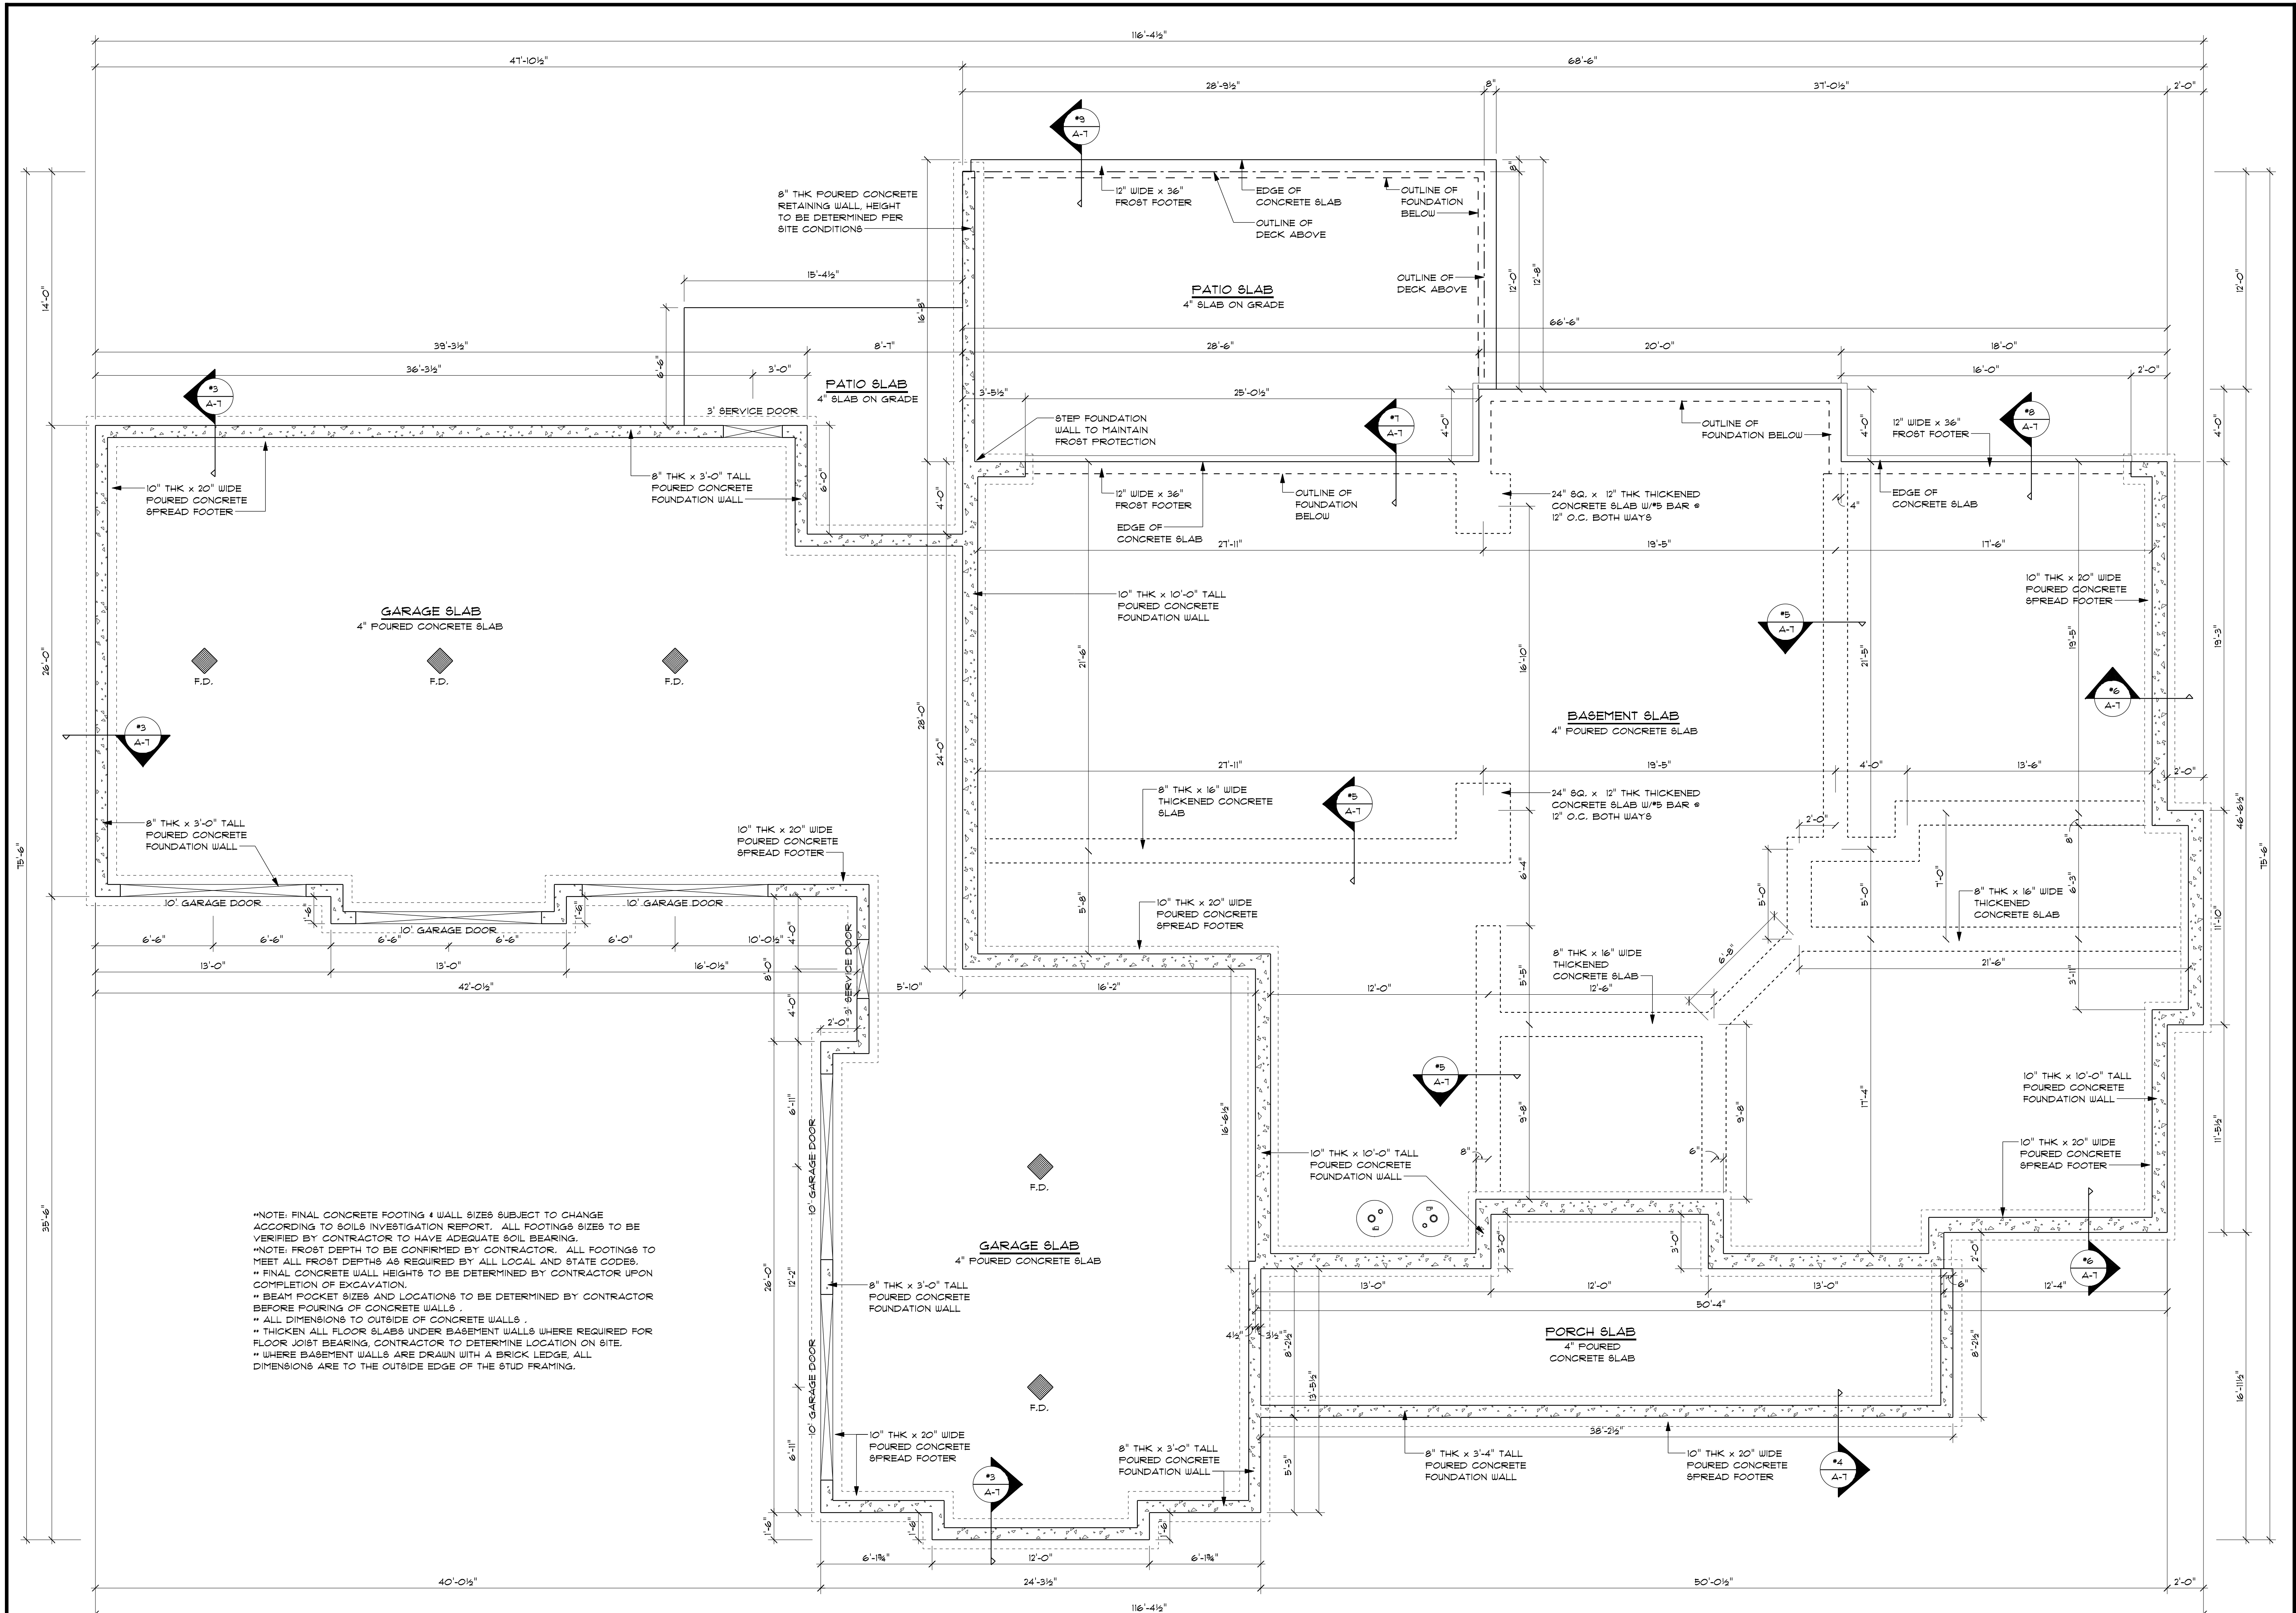FOUNDATION PLAN
 SCALE: 1/4" = 1'-0"

PROJECT DETAILS	
WINDOWS:	ANDERSEN 400 SERIES 10' CONC. WALL
FOUNDATION:	10' CONC. WALL
EXTERIOR WALLS:	2x6
GARAGE WALLS:	2x4
INTERIOR WALLS:	2x4
FIRST FLOOR:	10'-1 1/8"
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FOUNDATION PLAN
PLAN #2012

DRAWN BY:	BG
PROJECT:	2012
PRINT DATE:	10/18/2021
FINAL:	MAR. 20, 2020
SCALE:	1/4" = 1'-0"

A-6

PROJECT DETAILS

WINDOWS:	ANDERSEN 400 SERIES
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NOTES & SECTIONS
PLAN #2012


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A-7


OPENING SCHEDULE				
PRODUCT CODE	COUNT	OPENING ID	WIDTH	HEIGHT
DHP4262	3	3	4'-3 5/16"	6'-4 7/8"
TW2062-3	2	4	8'-11 1/2"	6'-4 7/8"
TW2052	2	5	2'-11 3/8"	5'-4 7/8"
TW2852-3	1	6	8'-5 1/8"	5'-4 7/8"
TW2102-2	2	7	5'-11 3/8"	7'-4 7/8"
DHP4262 - Transom				
A21-3	1	9	6'-0 3/8"	2'-0 1/2"
TW2052-2	3	10	5'-11 3/8"	5'-4 7/8"
TW2852-2	1	11	5'-7 3/8"	5'-4 7/8"
CX24	1	12	5'-2 3/4"	4'-0"
A21	2	13	2'-0 1/8"	2'-0 1/8"
TW21042-2	1	14	5'-11 3/8"	4'-4 7/8"
TW3452-3	1	15	10'-5 1/8"	5'-4 7/8"
CX14	1	16	2'-7 1/2"	4'-0"
TW2442	2	17	2'-5 3/8"	4'-4 7/8"
3'-0"x6'-8"	8	A	3'-0"	6'-8"
5'-0"x6'-8" DBL	3	D	5'-0"	6'-8"
3'-0"x6'-8" FKT	3	E	3'-0"	6'-8"
FUG16080-4 SAAS	2	F	15'-9"	7'-11 1/2"
30X80 GLASS	1	G	2'-6"	6'-8"
2'-8"x6'-8"	10	H	2'-8"	6'-8"
36" CRAFTSMAN	3	I	3'-0"	6'-8"
T2"x96" CRAFTSMAN - 11" TRANSOM	1	K	6'-0"	9'-6 1/2"
32" CRAFTSMAN	1	M	2'-8"	6'-8"
2'-8"x6'-8" FKT	4	N	2'-8"	6'-8"
3'-0"x6'-8" FKT-MODIFIED	1	P	3'-0"	6'-8"
3'-0"x6'-8" FKT-MODIFIED	1	Q	3'-0"	6'-8"
2'-6"x6'-8"	1	R	2'-6"	6'-8"
2'-4"x6'-8" FKT	2	T	2'-4"	6'-8"

GENERAL NOTES:


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- THIS BUILDING IS TO BE CONSTRUCTED AS REQUIRED BY THE INTERNATIONAL RESIDENTIAL CODE (IRC) THAT IS CURRENTLY IN EFFECT IN INDIANA.
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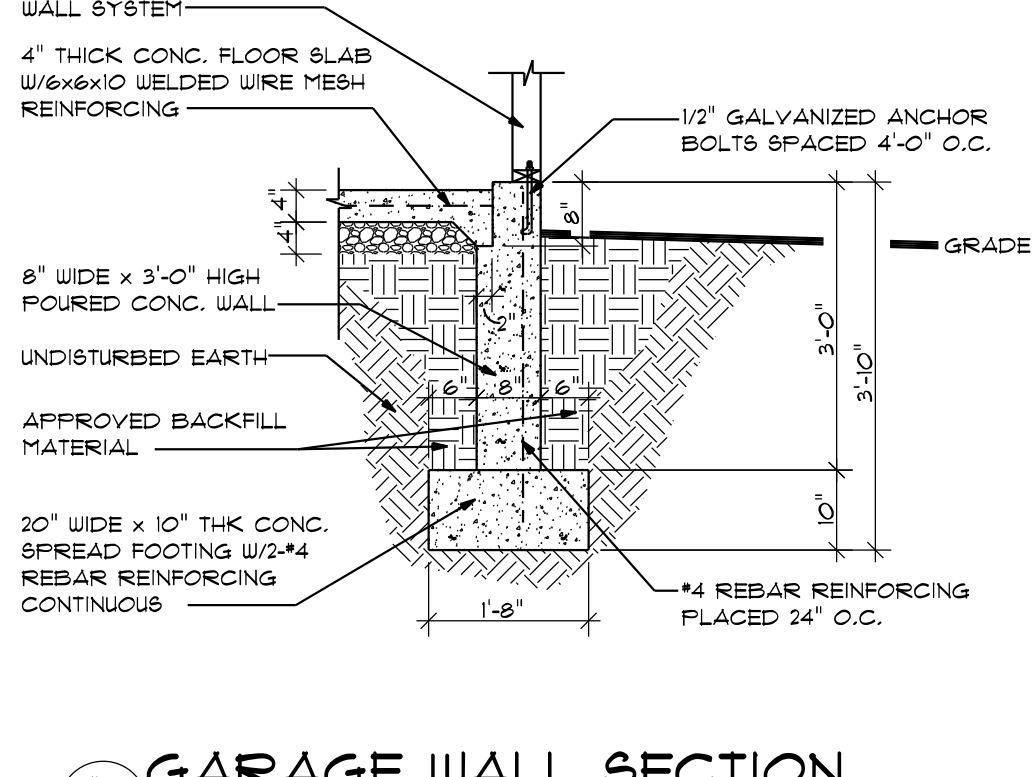
#1 FROST FOOTER SECTION
 A-1 SCALE: 1/2"=1'-0"

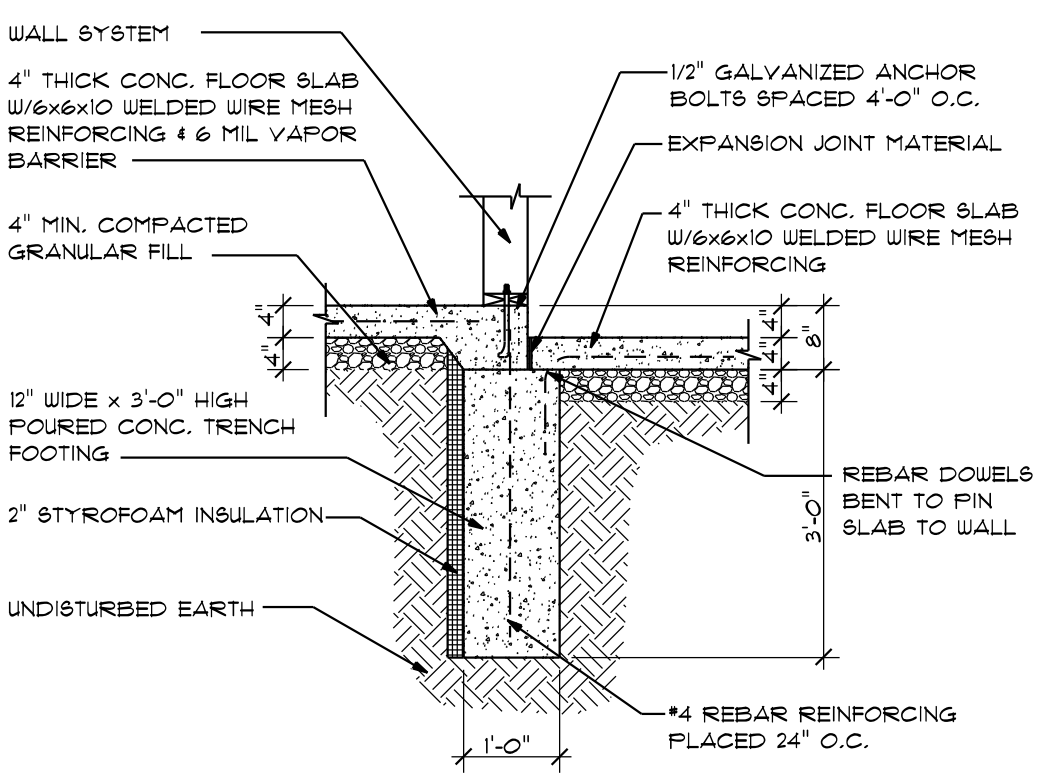


#2 FROST FOOTER SECTION
 A-1 SCALE: 1/2"=1'-0"

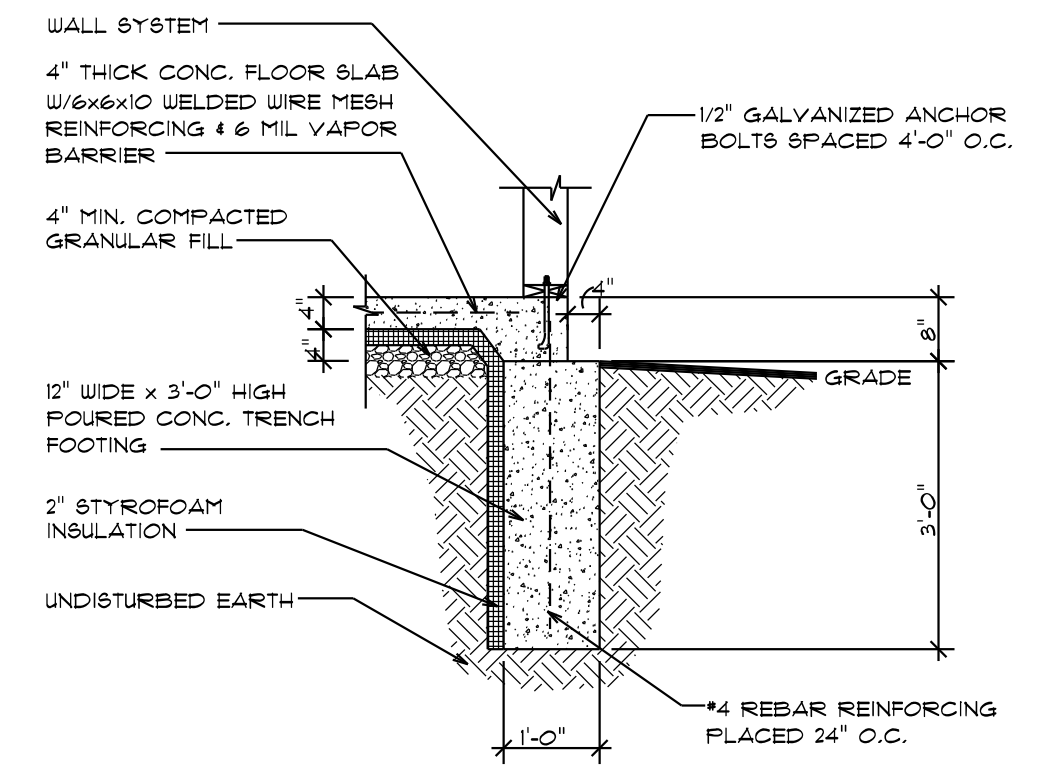


#3 PATIO FOOTER SECTION
 A-1 SCALE: 1/2"=1'-0"

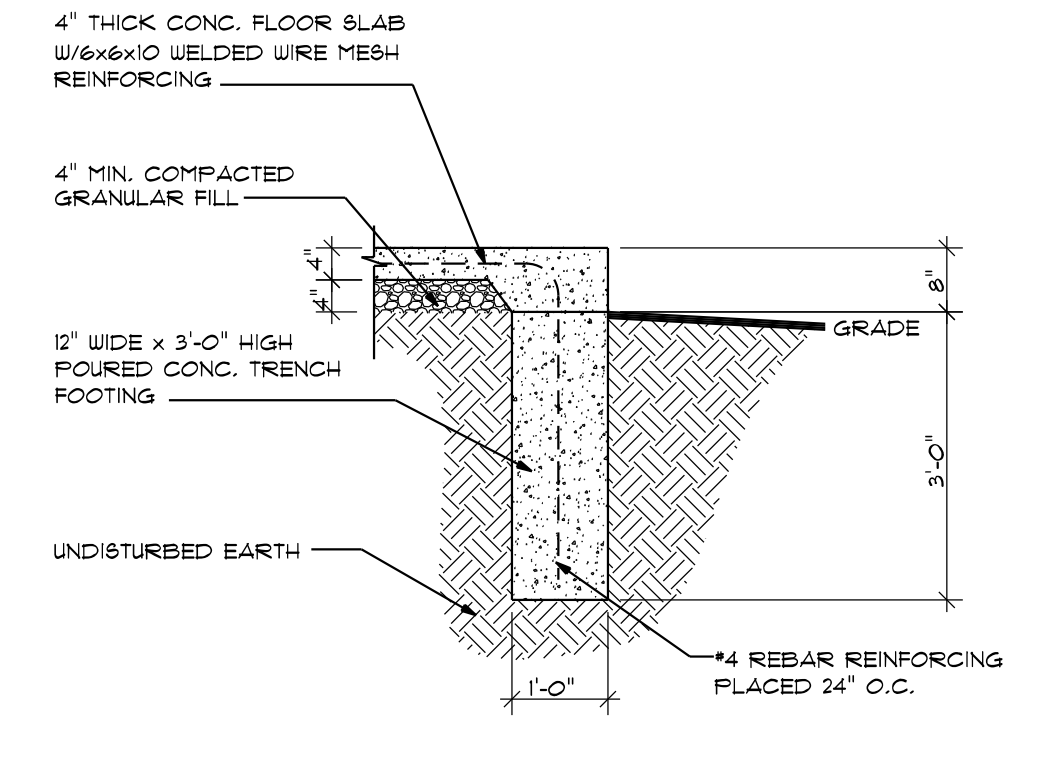


#3 GARAGE WALL SECTION
 A-1 SCALE: 1/2"=1'-0"

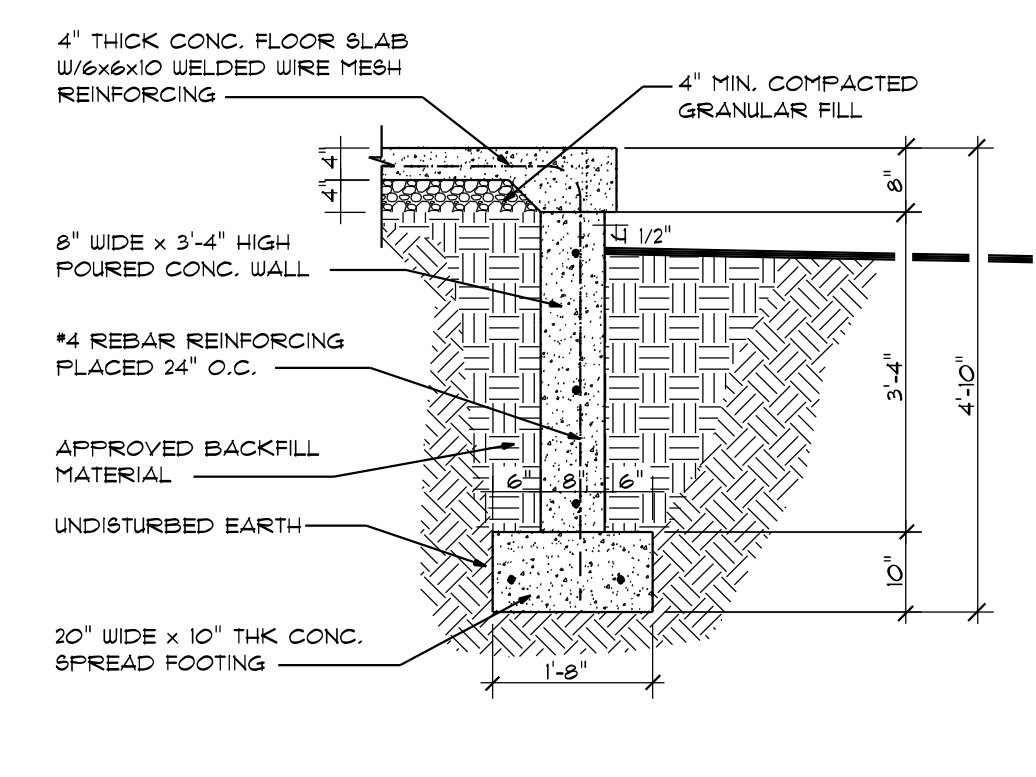


#4 PORCH WALL SECTION
 A-1 SCALE: 1/2"=1'-0"

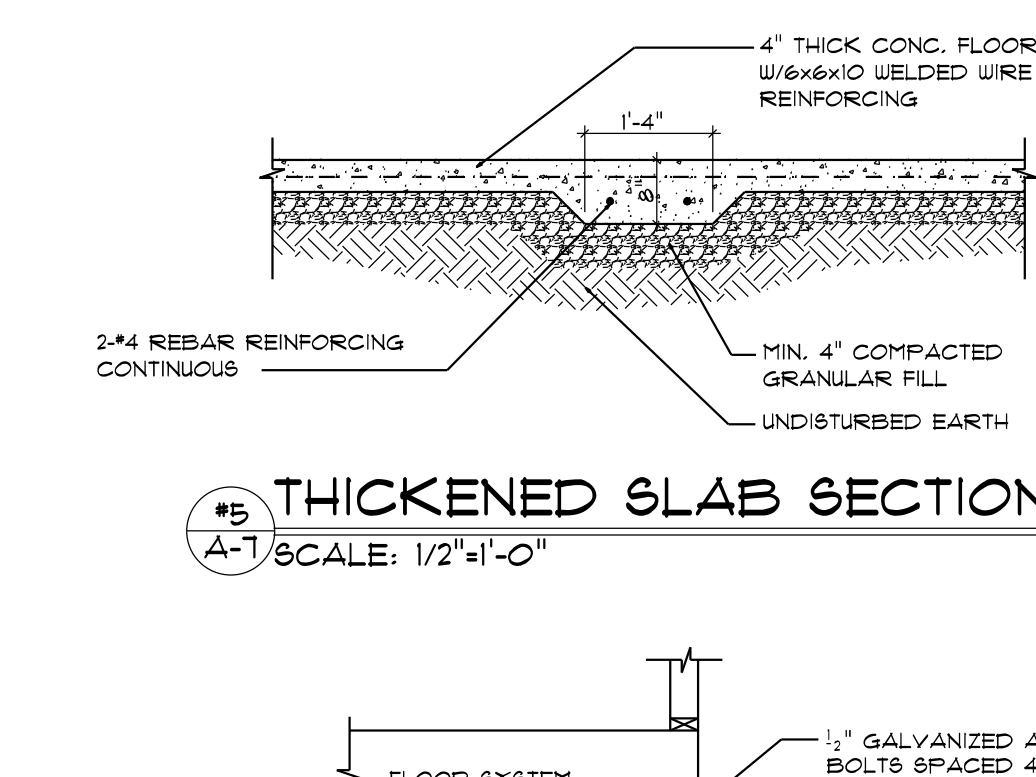


#5 THICKENED SLAB SECTION
 A-1 SCALE: 1/2"=1'-0"

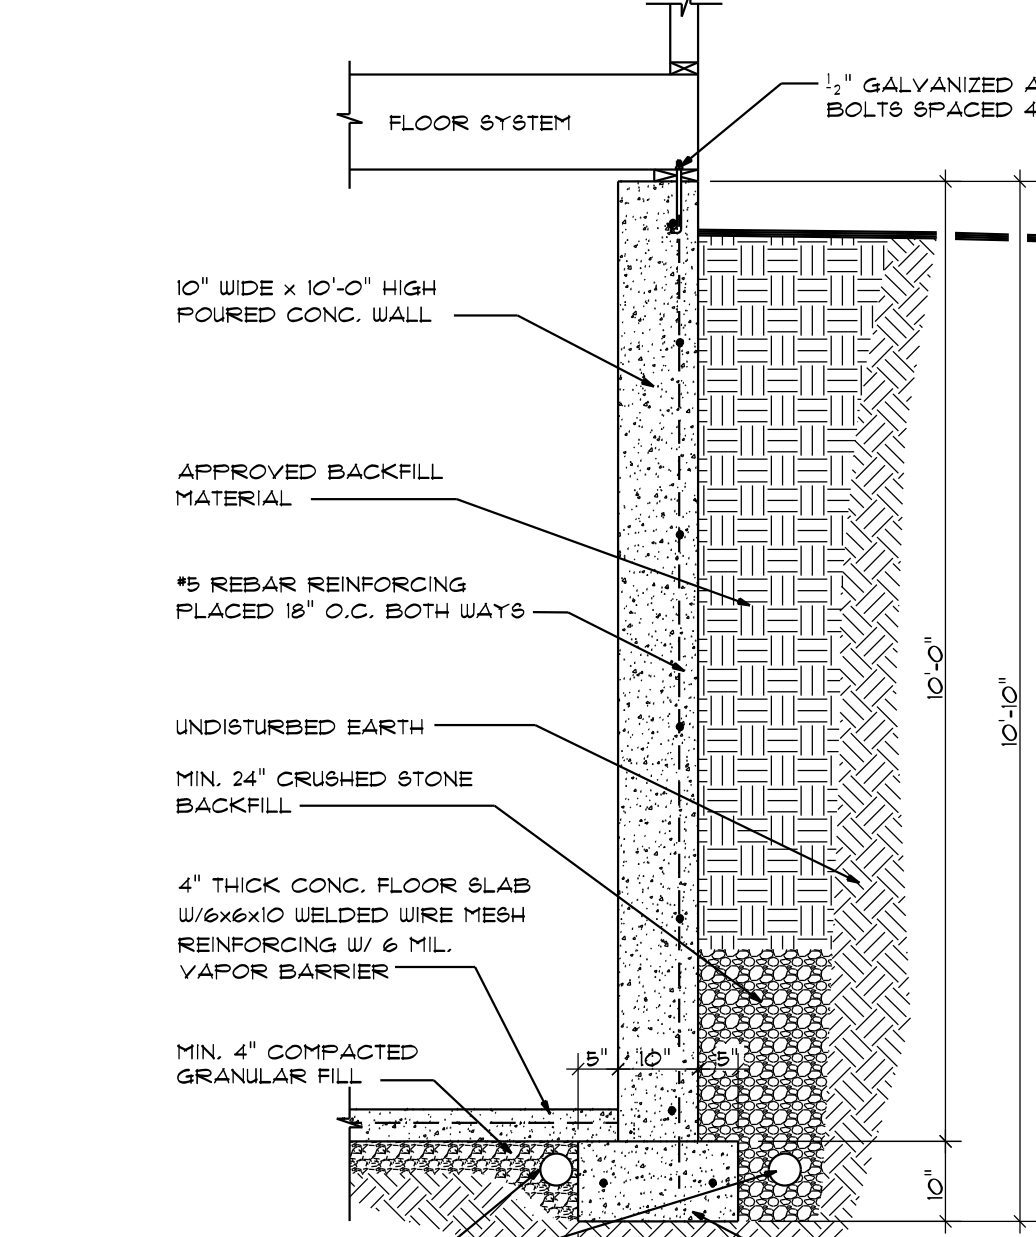

#6 BASEMENT WALL SECTION
 A-1 SCALE: 1/2"=1'-0"

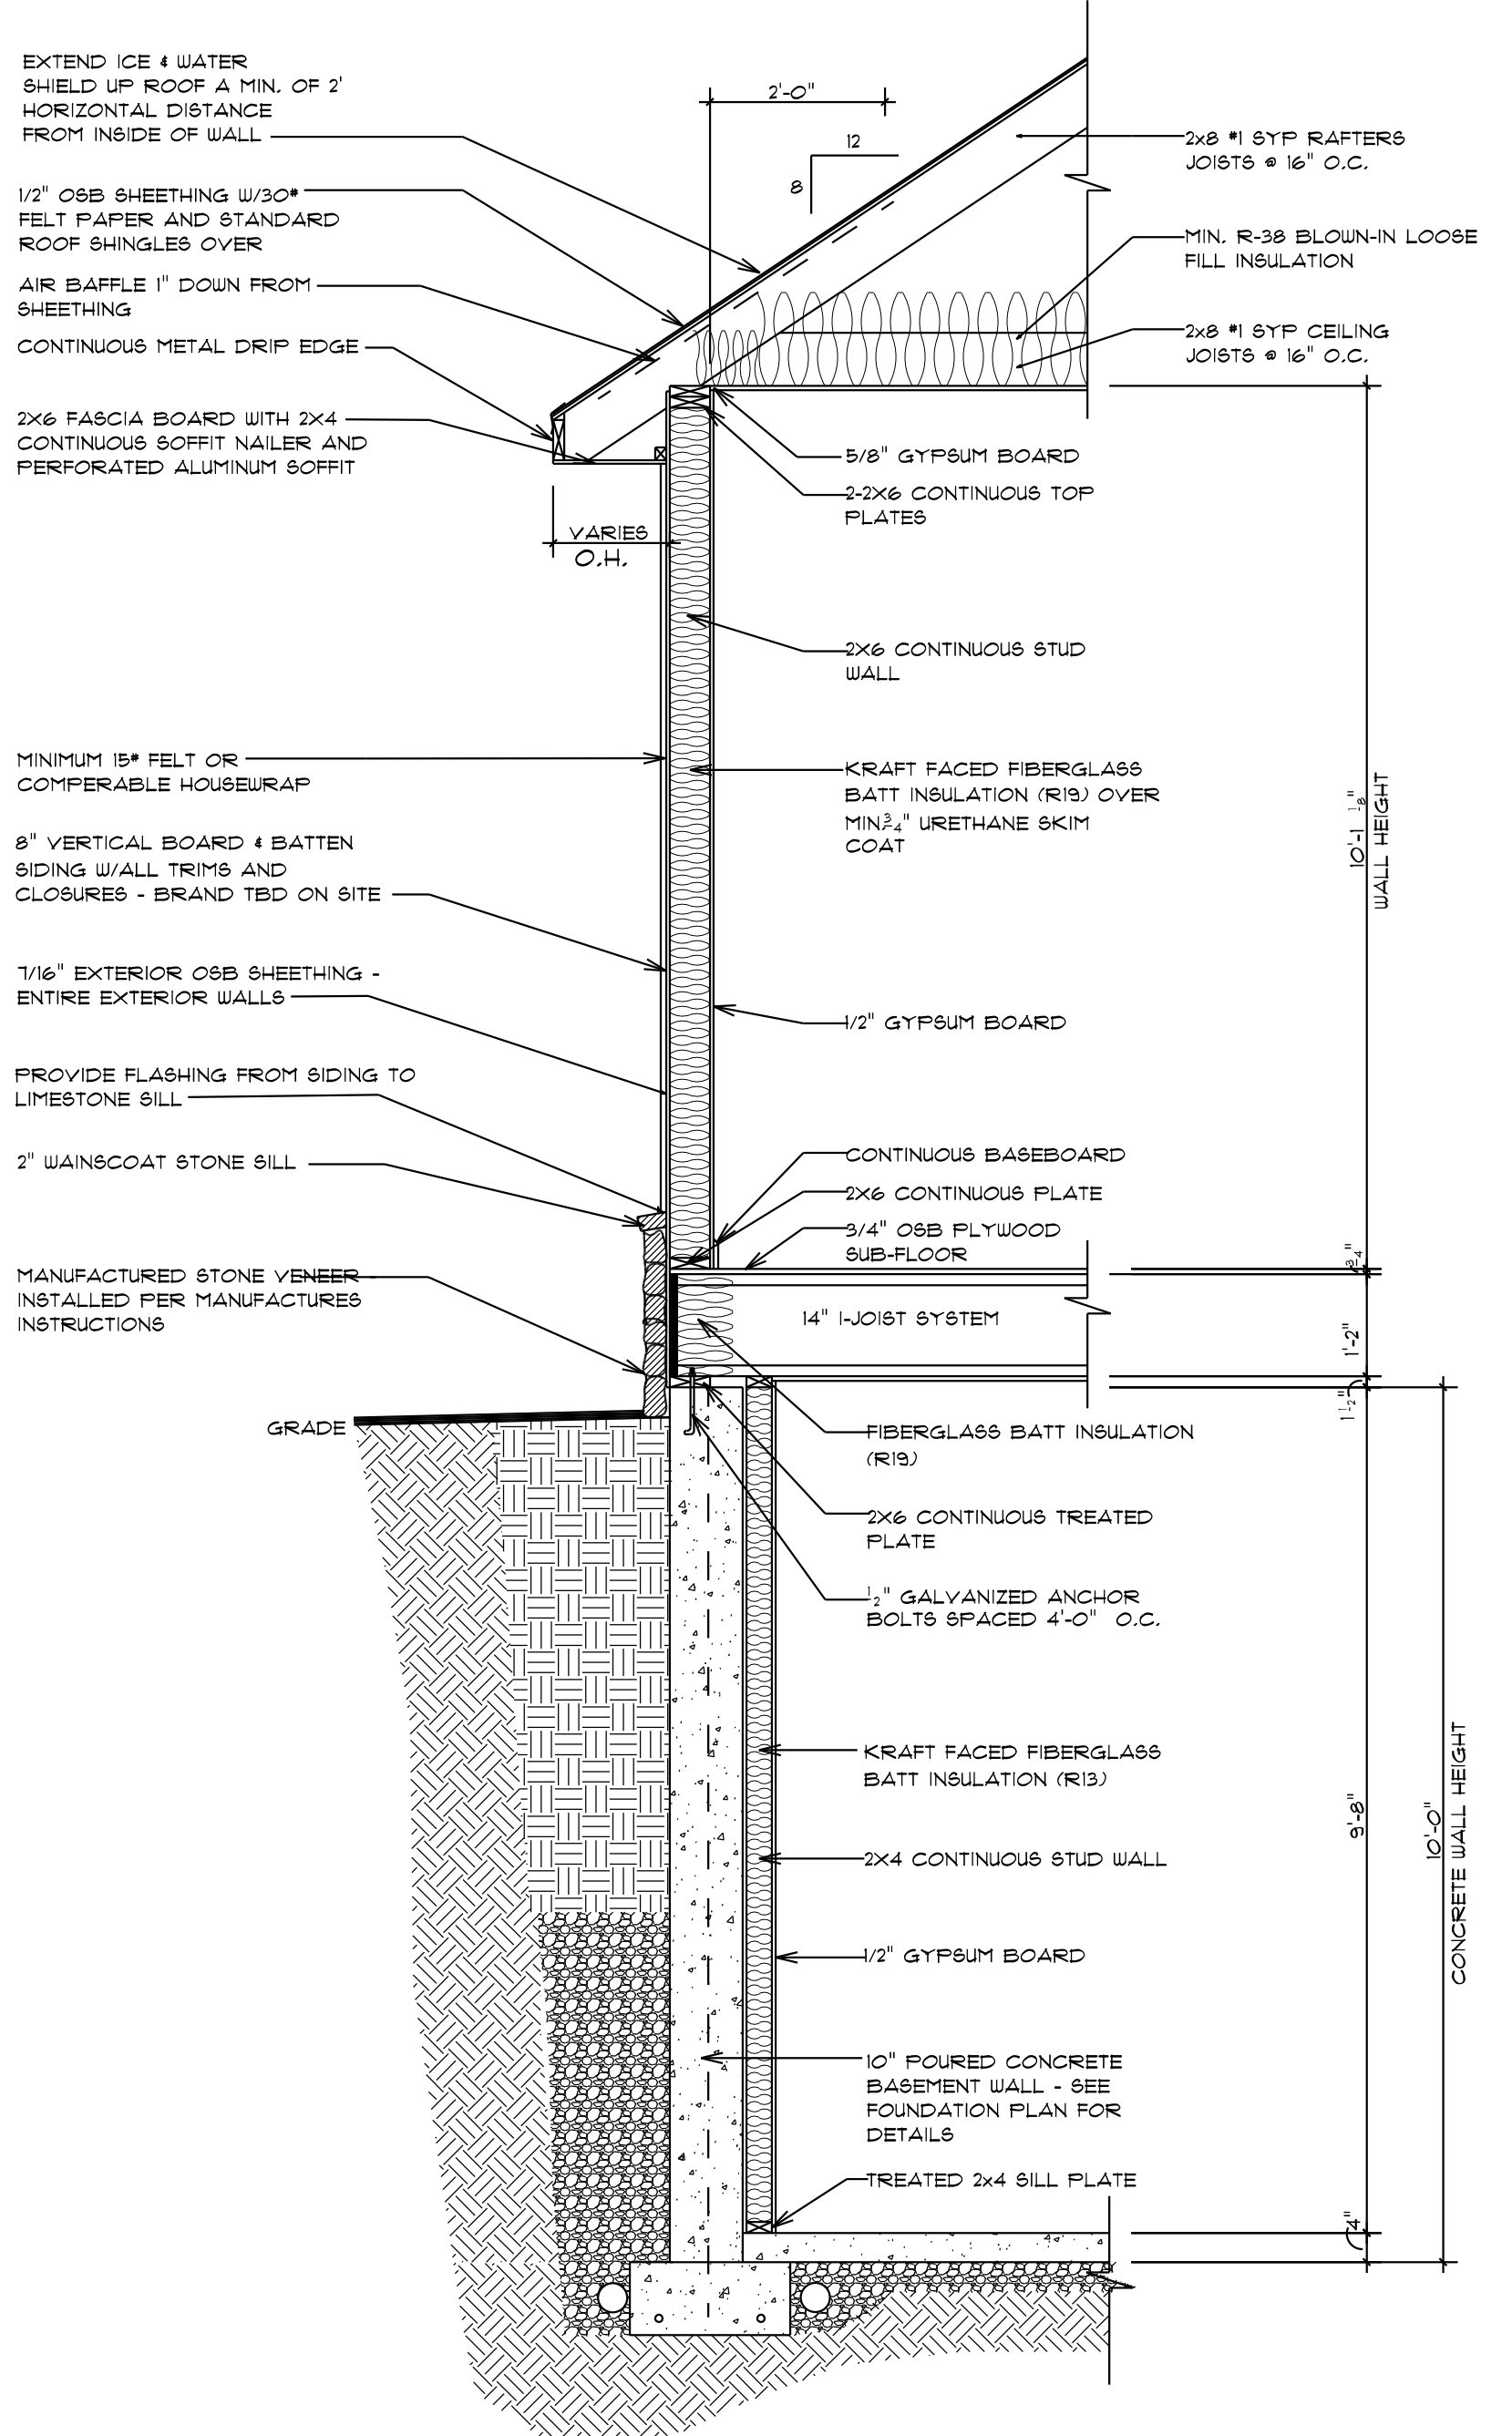

#2 TYP WALL SECTION
 A-1 SCALE: 1/2"=1'-0"

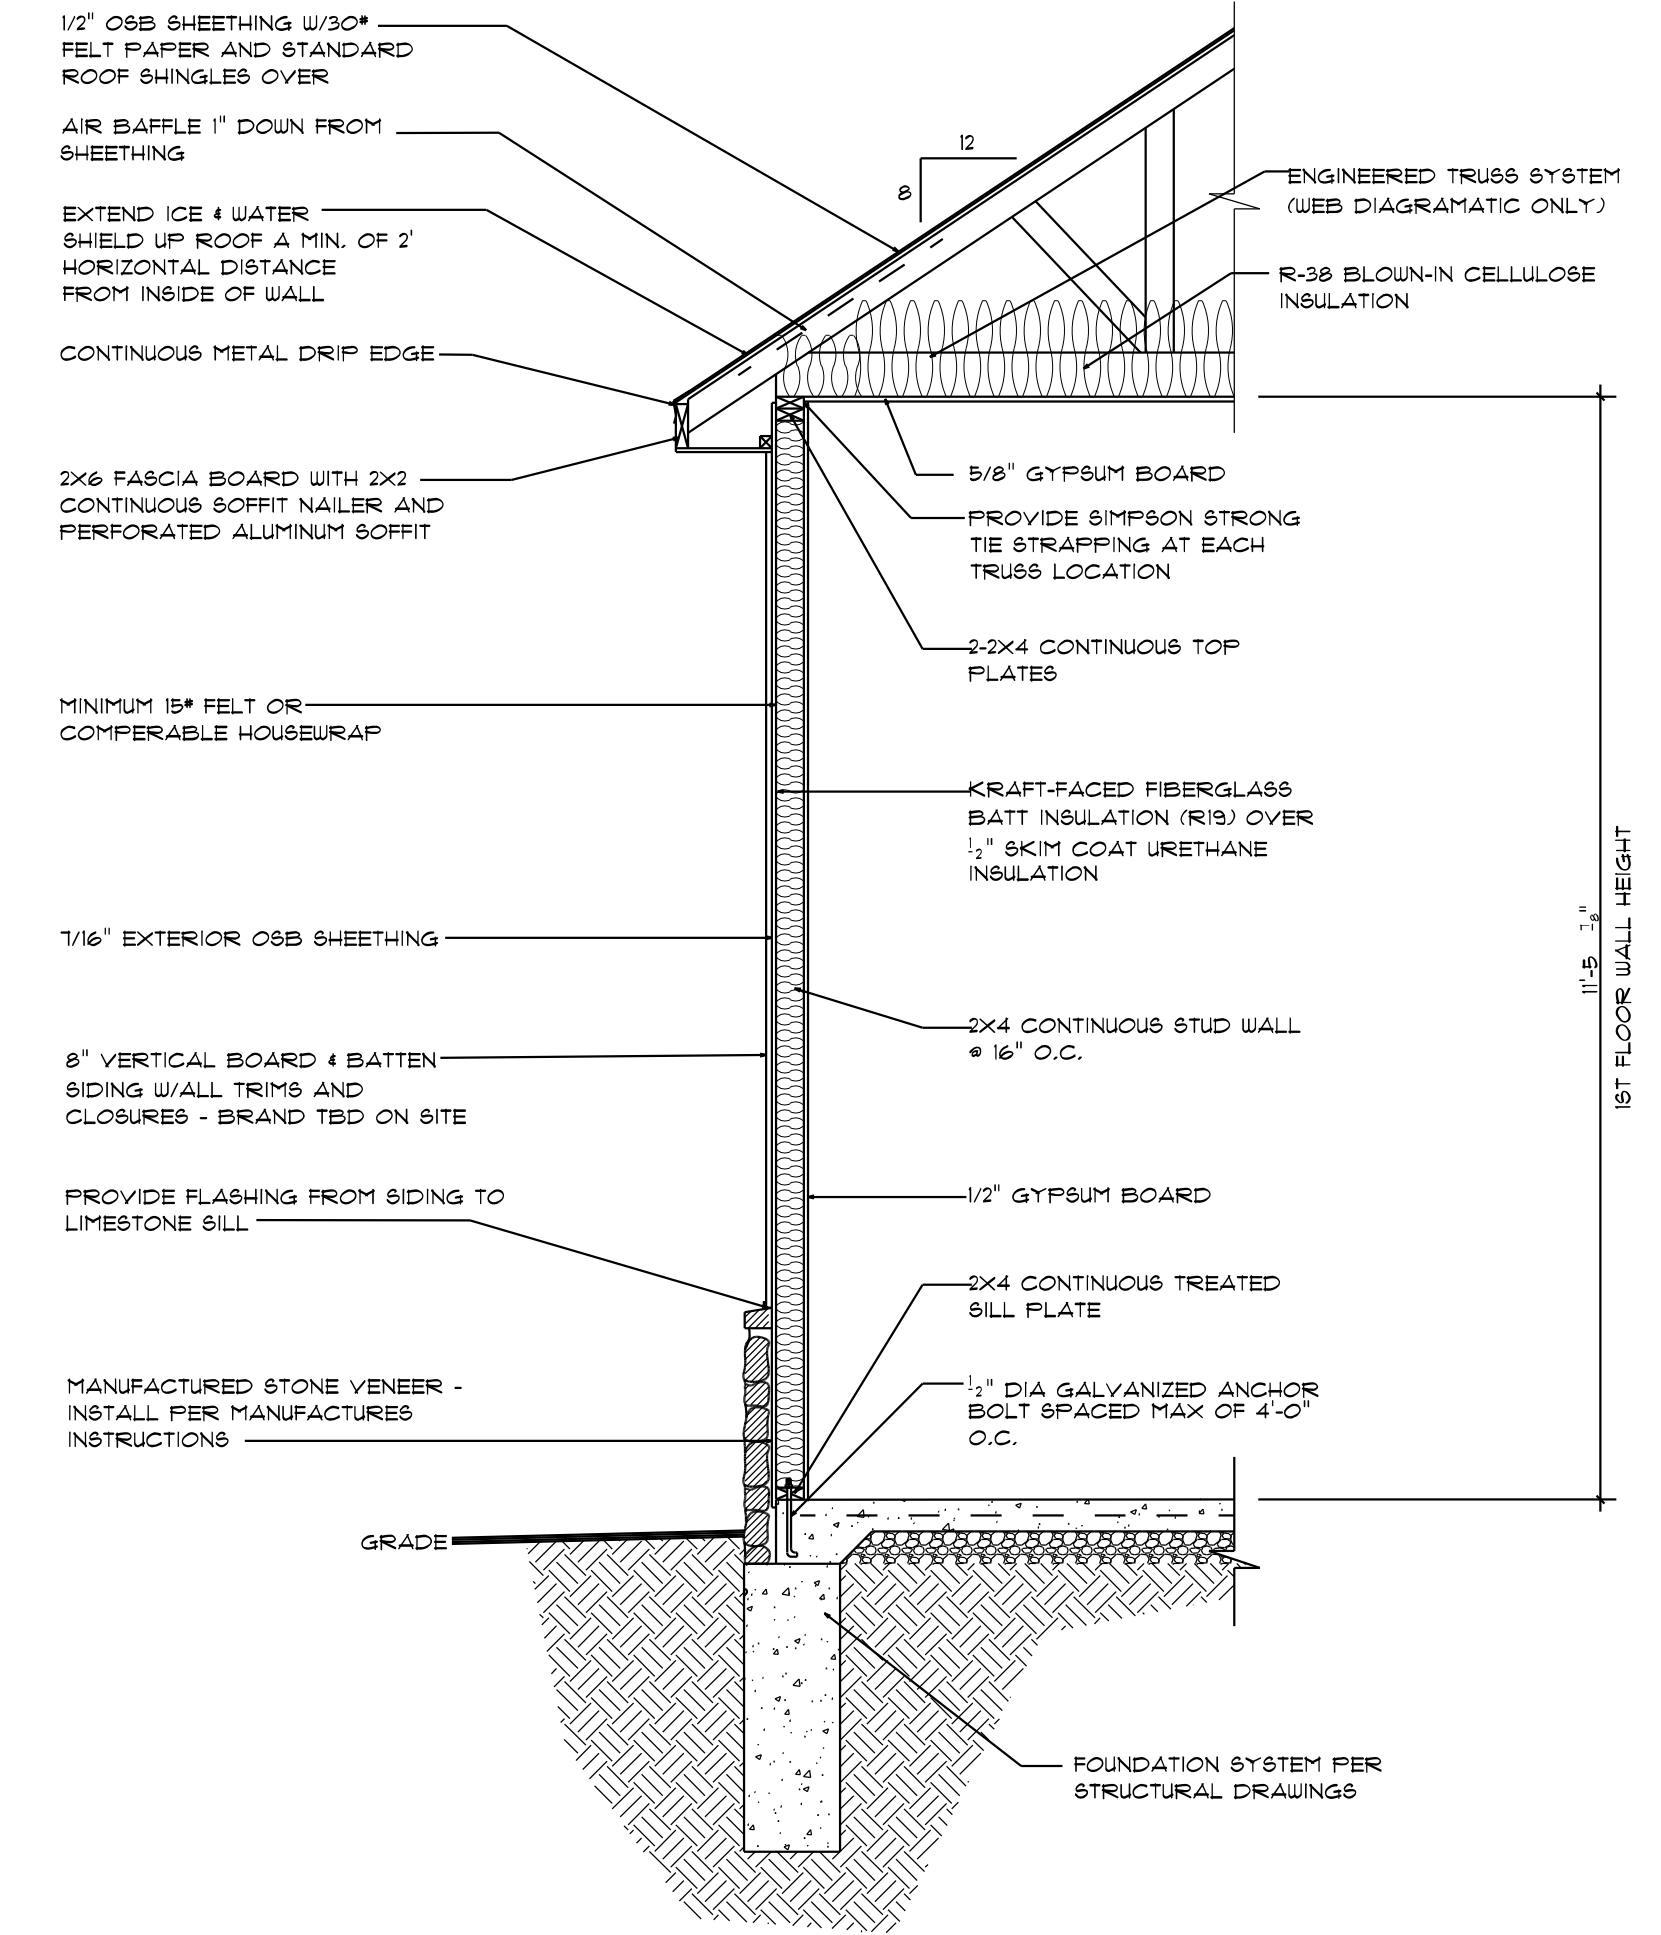

#1 GARAGE WALL SECTION
 A-1 SCALE: 1/2"=1'-0"

PROJECT DETAILS

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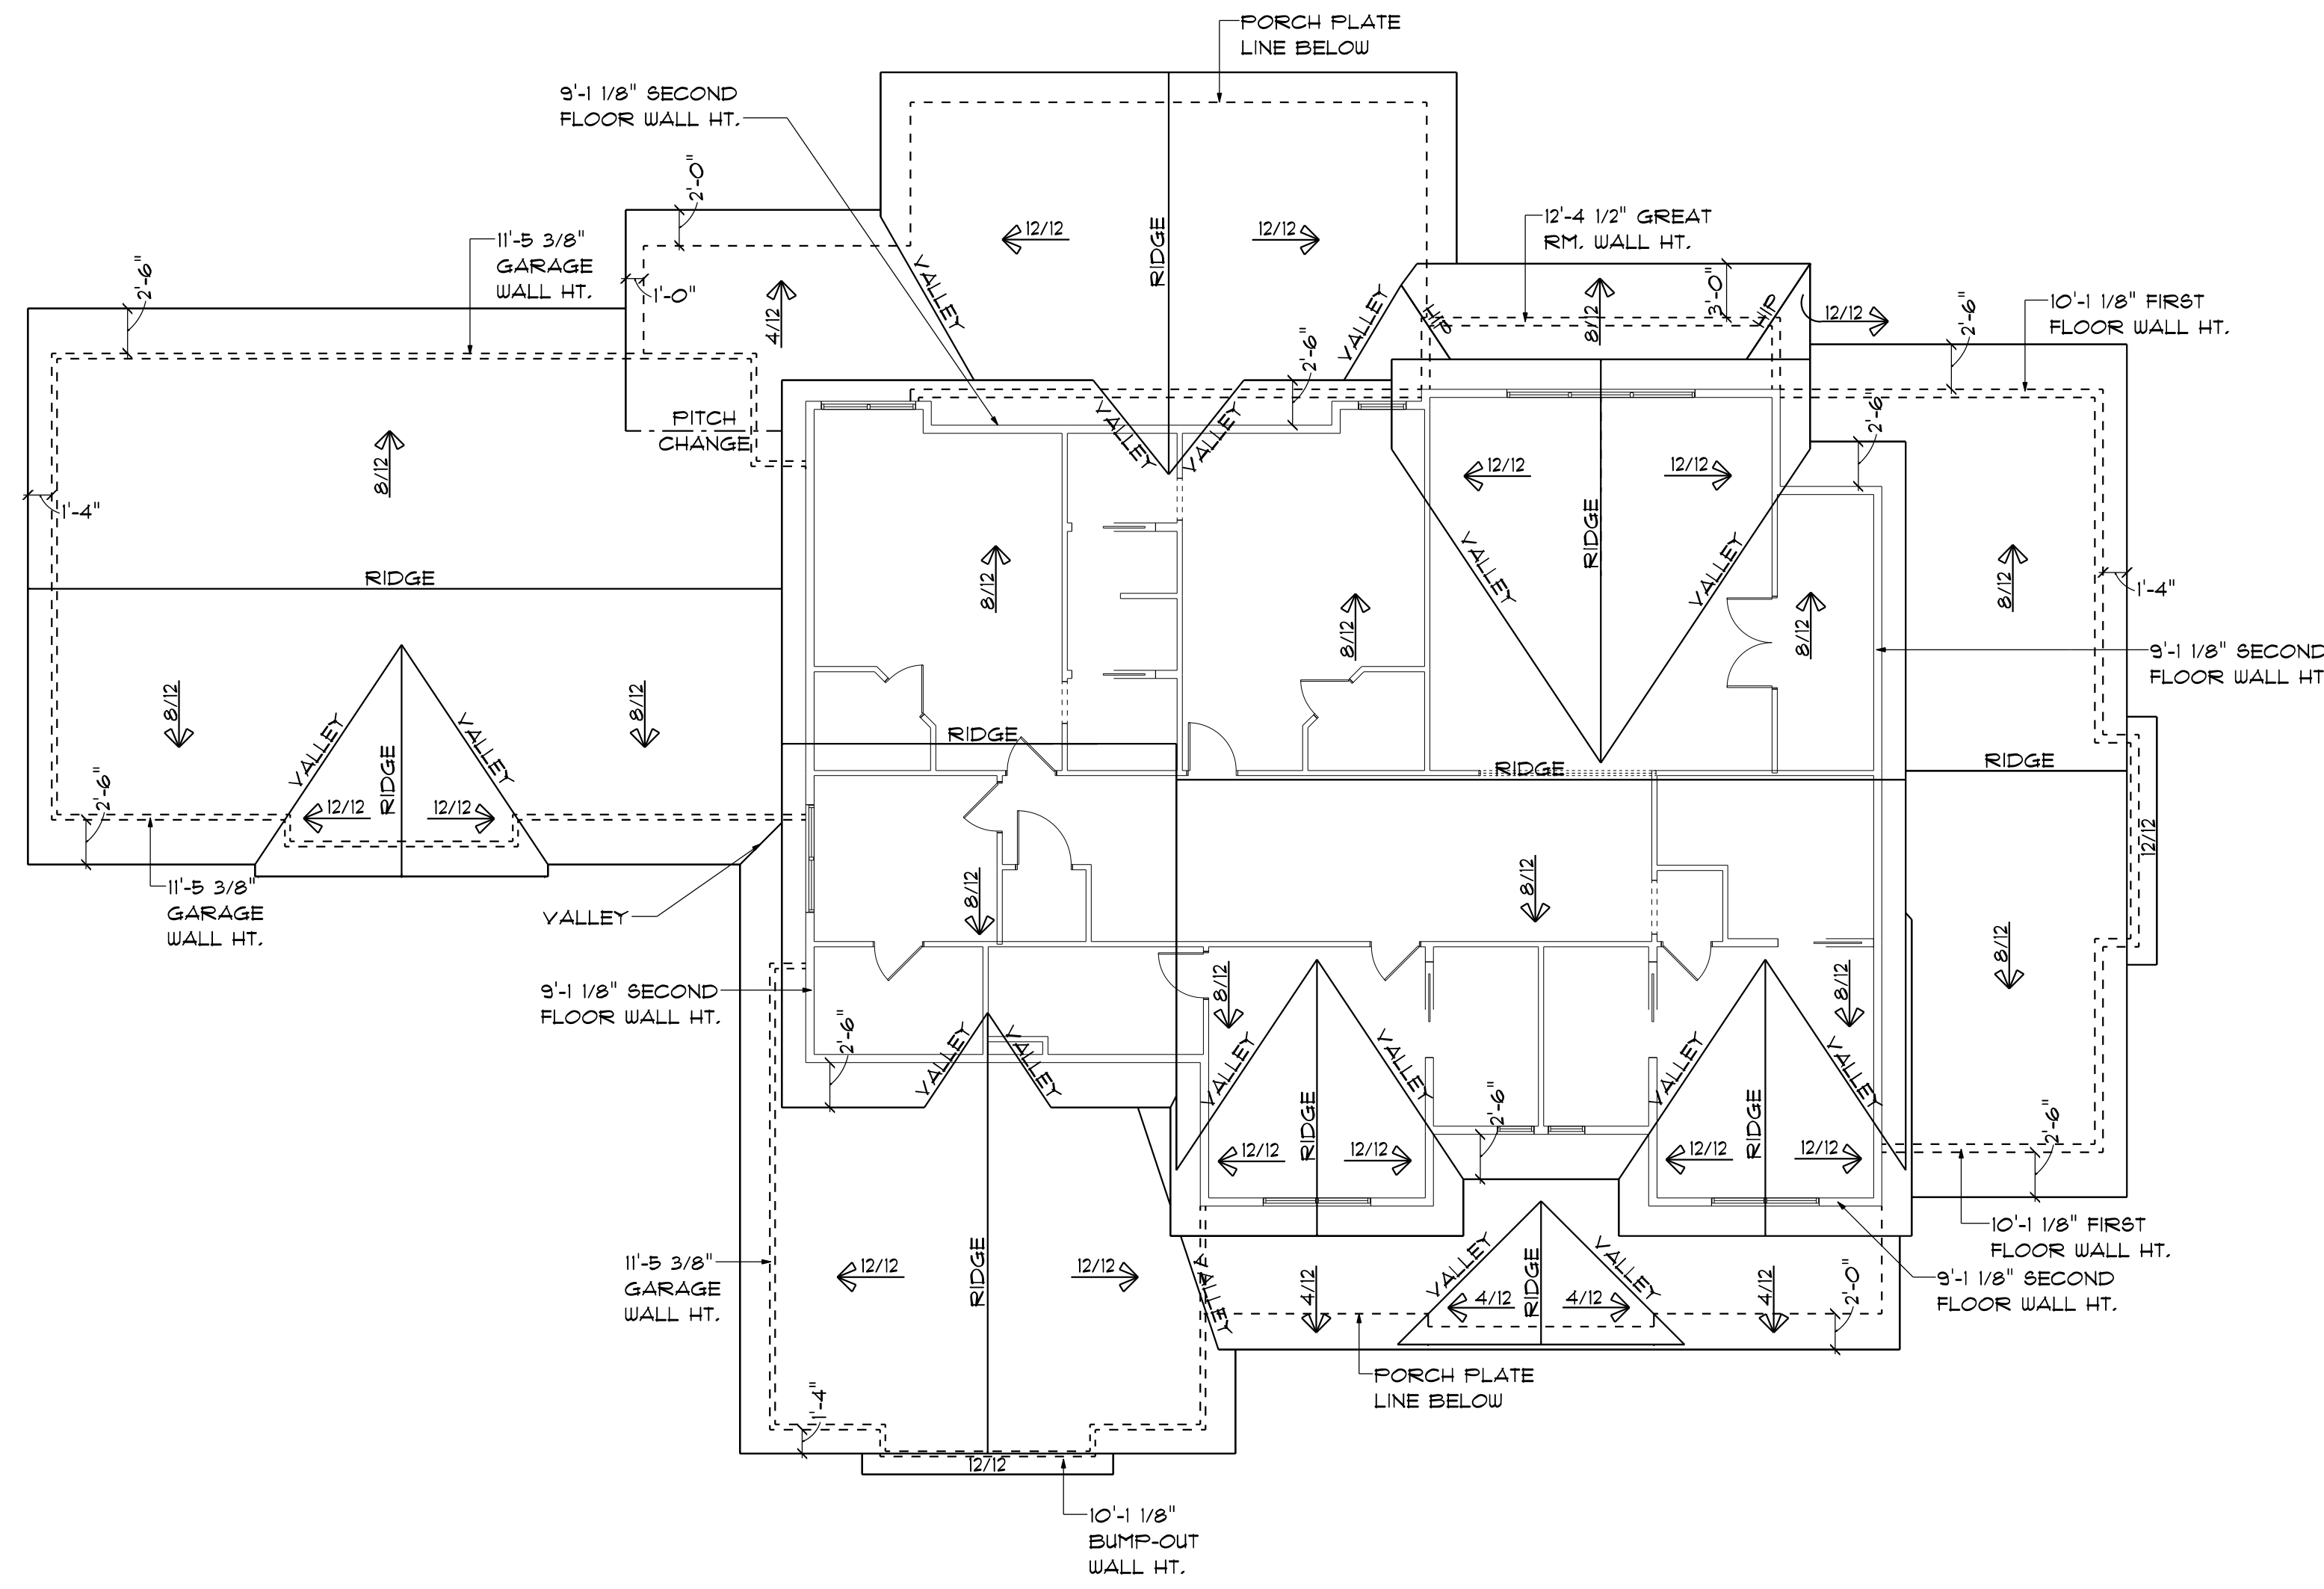
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ROOF PLAN
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DRAWN BY: BG
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 PRINT DATE:
 10/18/2021
 FINAL: MAR. 20, 2020
 SCALE: 1/4" = 1'-0"

ROOF NOTES:

1. ALL EAVE OVERHANGS TO BE 20" UNLESS NOTED OTHERWISE.
2. ALL GABLE OVERHANGS TO BE 20" UNLESS NOTED OTHERWISE.
3. ALL OVERHANGS DIMENSIONED FROM THE EXTERIOR WALL FRAMING.
4. CHANGE HEEL HEIGHTS, BEAM HEIGHTS, WALL HEIGHTS, AND OR OVERHANG DEPTHS WHERE DIFFERING ROOF PITCHES ARE USED.
5. ASSUME 5" HEEL HEIGHT, UNLESS NOTED OTHERWISE.



ROOF PLAN
 SCALE: 1/8" = 1'-0"

TERMS & CONDITIONS

1. Generally, "Customer" is the person or business who purchased this design plan. "Designer" is the designer of this design plan. The "Design Plan" includes the drawings, notes, recommendations and other materials provided by Designer to Customer regarding the house designed in the Design Plan. By purchasing this Design Plan and constructing the house designed in the Design Plan (the "House"), Customer agrees to the terms and conditions stated herein.

2. Design Plan Review. The Design Plan is not a comprehensive blueprint but is intended only to provide a general layout and aesthetic design of the House. The Design Plan provides information relevant to the general design of the House, but expressly does not include all information necessary to construct the House. Customer shall have the Design Plan reviewed by all applicable contractors and engineers, who shall be responsible to add the information necessary to build the House and ensure the House as constructed complies with all applicable local laws, building codes, local custom, and is suited to the environmental conditions in the place where the House is to be built.

3. Disclaimer. BY USING THE DESIGN PLAN TO CONSTRUCT A HOUSE, CUSTOMER UNDERSTANDS AND AGREES THAT DESIGNER EXPRESSLY DISCLAIMS ALL LIABILITY ARISING FROM OR RELATED TO THE CONSTRUCTION OF THE HOUSE. In the event that Designer shall be liable for any costs or damages of Customer, such liability shall be limited to the amount Customer paid for the Design Plan. Customer and its contractors, engineers, and agents, are exclusively responsible for ensuring the House and its construction comply with all laws, rules, codes, and regulations, as well as best practices in the location where the House is built.

4. License. Designer hereby grants Customer a license to use the Design Plan to build one House. This license is not transferrable or assignable by Customer to third parties.

RECOMMENDATIONS

Designer recommends that Customer and its agents, contractors, and engineers, construct the House in accordance with the following recommendations. Notwithstanding the foregoing, Customer agrees to have the following recommendations reviewed by applicable contractors and engineers to ensure the recommendations comply with local laws, rules, and regulations, and are applicable to the environmental conditions and best practices of the location where the House is being built.

CONCRETE

ALL MATERIAL AND WORKMANSHIP SHALL CONFORM TO ACI 318. ALL DETAILING, FABRICATION, ACCESSORIES, AND PLACEMENT OF REINFORCING SHALL CONFORM TO THE ACI MANUAL OF STANDARD PRACTICE FOR DETAILING REINFORCED CONCRETE STRUCTURES.

CONCRETE SHALL BE NORMAL WEIGHT GREY CONCRETE AND DEVELOPE A MINIMUM COMPRESSIVE STRENGTH OF 3000 PSI AT 28 DAYS.

BASEMENT AND FOUNDATION WALLS ARE TO BE CONSTRUCTED WITH POURED IN PLACE STEEL REINFORCED CONCRETE.

ALL SLABS ON GRADE SHALL BEAR ON 4" COMPACTED GRANULAR FILL WITH 6X6 WELDED WIRE MESH (WWM) CONFORMING TO ASTM A185. OVERLAP WWM MINIMUM OF 6" AT ALL SPLICES.

INTERIOR SLABS SHALL HAVE 6 MIL., POLYETHYLENE VAPOR BARRIER UNDERNEATH.

ALL 36"x36"x18" CONCRETE PADS ARE TO HAVE FOUR #4 RODS EACH WAY.

FOUNDATION'S BOLTS MUST BE ANCHORED TO SILL PLATE WITH 1/2" BOLTS EMBEDDED 15" INTO CONCRETE FOUNDATION WALL. ANCHOR BOLTS TO CONFORM TO ASTM A307. BOLTS SPACED 4'-0" O.C.

LAP ALL REINFORCING BARS A LENGTH OF 30 BAR DIAMETERS, MINIMUM. PROVIDE ONE CORNER BAR, LAPPED 30 BAR DIAMETERS EACH WAY, FOR EACH PIECE OF CONTINUOUS REINFORCING.

ALL CONSTRUCTION JOINTS ARE TO BE ROUGH-SURFACE AND CLEANED BEFORE THE NEXT POUR. NO HORIZONTAL CONSTRUCTION JOINTS PERMITTED IN FOUNDATION WALLS.

PROVIDE EXPANSION JOINTS WHERE REQUIRED BY LOCAL CODES AND FOR REQUIREMENTS.

CONTROL JOINTS IN CONCRETE SLABS SHALL BE LOCATED SO THAT THE MAXIMUM AREA WITHIN JOINTS IS 600 SF OR LESS, AND THE RATIO OF SIDE DIMENSIONS IS NO MORE THAN 2:1.

STEEL

ALL MATERIAL AND WORKMANSHIP SHALL CONFORM TO THE AISC SPECIFICATIONS FOR THE DESIGN, FABRICATION, AND ERECTION OF STRUCTURAL STEEL.

ALL STRUCTURAL STEEL FOR BEAMS AND PLATES SHALL COMPLY WITH ASTM A 572 GRADE 50.

ALL STRUCTURAL STEEL COLUMNS SHALL COMPLY WITH ASTM A 615 GRADE 60.

ALL WELDS SHALL BE MADE WITH E70XX ELECTRODES. ALL BUTT WELDS SHALL BE FULL PENETRATION. MINIMUM SIZE OF FILLET WELDS SHALL CONFORM TO AISC SPECIFICATIONS.

WOOD FRAMING

ALL WOOD FRAMING AND MATERIALS SHALL COMPLY WITH THE NATIONAL DESIGN SPECIFICATIONS FOR WOOD CONSTRUCTION PUBLISHED BY THE NATIONAL FOREST PRODUCTS ASSOCIATION.

UNLESS NOTED OTHERWISE, ALL FRAMING LUMBER IS TO BE FIR #2, SOUTHERN PINE #2, OR EQUAL.

LUMBER FOR 2X4 OR 2X6 STUD PARTITIONS SHALL BE STUD GRADE SPRUCE-PINE-FIR OR EQUAL.

ALL EXTERIOR STUD WALLS ARE TO BE CONSTRUCTED OF 2X4 OR 2X6 STUDS AT 16" O.C. ALL STUD WALLS TALLER THAN 9'-0" ARE TO BE BLOCKED SOLID TWICE AT THE THIRD HEIGHTS.

ALL HEADERS AND BEAMS ARE TO BE SUPPORTED BY BUILD-UP FRAMING LUMBER OR COLUMNS. SUPPORT IS TO BE CONTINUOUS TO THE FOUNDATION.

ALL KNEE-WALL CONSTRUCTION TO BE DIAGONALLY BRACED AT 4'-0" O.C. MAXIMUM.

ANY STRUCTURAL AND/OR FRAMING MEMBERS NOT INDICATED ON THE PLAN ARE TO BE SIZED BY THE CONTRACTOR. DESIGN SIZES REFERENCED FOR BEAMS OR HEADERS GIVEN ON THE PLANS ARE FOR REFERENCE ONLY. CONSULT WITH A LICENSED STRUCTURAL ENGINEER PRIOR TO COMMENCEMENT OF CONSTRUCTION FOR FINAL BEAM AND HEADER SIZING.

LUMBER TO BE IN CONTACT WITH CONCRETE OR MASONRY SHALL BE PRESSURE-TREATED LUMBER.

ALL EXTERIOR WALLS ARE DIMENSIONED TO OUTSIDE OF WALL FRAMING.

ALL INTERIOR WALLS ARE DIMENSIONED TO FACE OF STUDS.

ALL EXTERIOR WALLS, INCLUDING GARAGE, ARE TO HAVE 1/2" OSB SHEATHING ON THE FACE.

ALL TRUSSES ARE TO BE ENGINEERED AND CONSTRUCTED BY A TPI MEMBER TRUSS MANUFACTURER. INSTALL

TEMPORARY AND PERMANENT BRIDGING PER TRUSS MANUFACTURER'S RECOMMENDATIONS.

ONE ROW OF 2X4 WOOD, CROSS-BRACING OR SOLID BLOCKING, ON ALL SPANS OVER 16'-0".

COLLAR TIES ARE TO BE SPACED AT 4'O.C.

ALL FURLINS AND KICKERS ARE TO BE 2"x6" UNLESS NOTED OTHERWISE.

ANY HIP OR VALLEY RAFTERS OF 24'-0" SPAN OR GREATER ARE TO BE LAMINATED VENEER LUMBER (LVL).

DESIGN LOADS

Floor: 40 P&F Live load 15 P&F Dead load	Attic: 30 P&F In Storage Areas 10 P&F where no storage
Roof: 30 P&F Live load 15 P&F Dead Load	Assumed Soil Bearing Capacity: 2000 P&F Verify soil bearing capacity on site.

MISCELLANEOUS

THE GENERAL CONTRACTOR SHALL OBTAIN ALL NECESSARY SURVEYS NEEDED TO LOCATE EXISTING SITE UTILITY SERVICES AND SHALL COORDINATE WITH ALL UTILITY COMPANIES REGARDING THE DISCONNECTION OF EXISTING SERVICES AND THE RECONNECTION OF NEW SYSTEMS. THE CONTRACTOR SHALL OBTAIN ALL NECESSARY BUILDING PERMITS PRIOR TO COMMENCEMENT OF WORK.

NOTED DIMENSIONS TAKE PRECEDENCE OVER SCALED DIMENSIONS.

FOUNDATION WALLS ARE NOT TO BE BACKFILLED UNTIL HOUSE IS COMPLETELY FRAMED AND ROOF OF STRUCTURE IS IN PLACE.

BACKFILL SHALL BE FREE OF DELETERIOUS MATERIAL AND SHALL HAVE A MINIMUM OF 90% STANDARD PROCTOR DENSITY.

BOTTOM OF FOOTINGS TO BE BELOW FROST DEPTH.

PROVIDE TERMITE PROTECTION AS REQUIRED BY HUD MINIMUM PROPERTY STANDARDS.

PREFABRICATED FIREPLACES AND FLUES ARE TO BE U.L. APPROVED AND INSTALLED PER MANUFACTURER'S RECOMMENDATIONS.

ALL MATERIALS, SUPPLIES AND EQUIPMENT ARE TO BE INSTALLED PER MANUFACTURER'S SPECIFICATIONS AND AS PER LOCAL CODES AND REQUIREMENTS.

1/2" WATER RESISTANT DRYWALL TO BE INSTALLED AROUND SHOWER AND TUBS.

1/2" DRYWALL ON INTERIOR WALLS AND 5/8" DRYWALL ON CEILINGS UNLESS NOTED OTHERWISE.

5/8" TYPE-X GYPSUM WALLBOARD ON GARAGE WALLS AND CEILINGS.

THE CONTRACTOR IS RESPONSIBLE THAT ALL MECHANICAL AND ELECTRICAL SYSTEMS ARE DESIGNED AND INSTALLED PER APPLICABLE CODES. ALL SUBCONTRACTORS SHALL BE RESPONSIBLE TO COORDINATE WITH THE GENERAL CONTRACTOR AS WELL AS ALL OTHER TRADES AS NECESSARY. THE GENERAL CONTRACTOR WILL COORDINATE WITH THE OWNER AND THE DESIGN CONSULTANT WITH REGARD TO THE LOCATION OF FIXTURES AND MECHANICAL SYSTEM COMPONENTS.

THE CONTRACTOR IS RESPONSIBLE TO VERIFY ALL DIMENSIONS IN THE FIELD.

"V.I.F." VERIFY IN FIELD. DIMENSION MAY BE VARIABLE OR MAY BE DETERMINED BY RELATED FACTORS.

ELECTRICAL NOTES

ELECTRICAL RECEPTACLES SHALL BE NO MORE THAN 12 FT. APART INCLUDING ANY WALL 2 FT. OR WIDER (BATHROOMS AND UTILITY ROOMS EXCEPTED).

ALL 120 VOLT, SINGLE PHASE, 15 AND 20 AMP HORIZONTALLY OF THE KITCHEN SINK, IN BATHROOMS,

RECEPTACLES INSTALLED WITHIN 6 FT., MEASURED IN GARAGES, OUTDOORS OR IN LAUNDRY ROOMS SHALL HAVE GROUND FAULT CIRCUIT INTERRUPT PROTECTION.

RECEPTACLES AT CONSTRUCTION POST, GARAGE AND BATHS TO BE G.F.I.C.

ALL SLEEPING ROOMS SHALL BE PROVIDED WITH AT LEAST ONE BEDSIDE OUTLET CONTROLLED BY SWITCH.

BATHROOMS SHALL BE PROVIDED WITH SWITCHES CONTROLLING LIGHT FIXTURES AND MECHANICAL VENTILATION.

EXTERIOR LIGHT FIXTURES SHALL BE PROVIDED AT

ALL DOORS TO THE EXTERIOR. SWITCHES SHALL BE PROVIDED NEAR DOORS CONTROLLING OUTDOOR LIGHT FIXTURES.

A BARE COPPER WIRE (20 FT. OF #2) SHALL BE WRAPPED AROUND THE LOWEST PIECE OF FOOTING REBAR AND SHALL TERMINATE WITH ENOUGH WIRE TO REACH THE ELECTRICAL SERVICE PANEL FOR USE AS A GROUND SOURCE.

PRE-WIRE FOR PHONE AND T.V.

200 AMP MAIN PANEL WITH CIRCUIT PANELS.

MINIMUM 12 GAUGE WIRE THROUGH-OUT.

REINFORCE ALL CEILING MOUNTED LIGHTS, FIXTURES, AND/OR DEVICES.

PROVIDE FRONT DOOR CHIME.

OUTLETS, SWITCH BOXES AND DEVICES ON EXTERIOR WALLS SHALL BE INSTALLED WITH SEALANT, GASKETING AND FLASHINGS AS REQUIRED.

AT LEAST ONE LIGHTING OUTLET SHALL BE INSTALLED IN ATTICS, UNDER FLOOR SPACE, IN UTILITY ROOMS, IN BASEMENTS USED FOR STORAGE OR WHERE EQUIPMENT EXTERIOR EXITS REQUIRING SERVICING IS LOCATED, AND AT BASEMENT

PROVIDE A DEDICATED 20 AMP CIRCUIT TO SERVE THE REQUIRED BATHROOM OUTLETS. THIS CIRCUIT CANNOT SUPPLY ANY OTHER RECEPTACLES, LIGHTS, FANS, ETC.

RECEPTACLES ARE REQUIRED AT THE FRONT AND REAR OF THE HOME, AND THEY MUST BE WITHIN 6'-6" OF GRADE, AND WEATHERPROOF GFCI PROTECTED.

EXHAUST FANS SHALL HAVE BACKDRAFT DAMPERS OR AUTOMATIC DAMPERS.

ELECTRICAL LIGHTING FIXTURES IN CLOTHES CLOSET SHALL BE INSTALLED WITH A MINIMUM OF 18 INCHES CLEARANCE TO COMBUSTIBLE MATERIALS. FIXTURES SHALL BE VERTICALLY CLEAR TO FLOOR OR RECESSED. INSTALLATION INSTRUCTIONS FOR ALL LISTED EQUIPMENT SHALL BE PROVIDED TO THE FIELD INSPECTOR AT TIME OF INSPECTION.

FIRE-WARNING SYSTEMS


PROVIDE MINIMUM OF ONE SMOKE DETECTOR PER FLOOR.

SMOKE DETECTORS TO BE PROVIDED ABOVE DOOR AT EACH SLEEPING ROOM.

CONNECT SMOKE DETECTORS TO HOUSE POWER AND INSTALL INTERCONNECT SO THAT WHEN ANY ONE IS TRIPPED, ALL UNITS WILL SOUND.

PROVIDE BATTERY BACK-UP FOR ALL UNITS.

NOTCHING AND BORING STUDS:

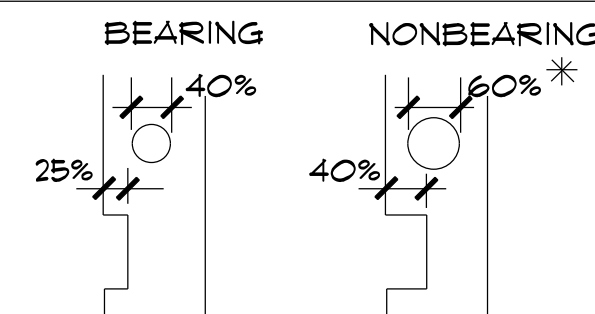

SOUND INSULATION

PROVIDE SOUND INSULATION IN ALL WALLS BETWEEN BATHROOMS AND ADJACENT ROOMS.

ALL EXPOSED INSULATION MATERIALS, INCLUDING FACINGS, SUCH AS VAPOR BARRIERS OR BREATHER PAPER, INSTALLED WITH IN FLOOR-CEILING ASSEMBLIES, ROOF-CEILING ASSEMBLIES, WALL ASSEMBLIES, CRAWL SPACES AND ATTICS SHALL HAVE A FLAME-SPREAD RATING NOT TO EXCEED 25 WITH A ACCOMPANYING SMOKE DEVELOPED FACTOR NOT TO EXCEED 450 WHEN TESTED IN ACCORDANCE ASTM E 84. EXCEPTION: WHEN SUCH MATERIALS ARE INSTALLED IN CONCEALED SPACES, THE FLAME-SPREAD AND SMOKE-DEVELOPMENT LIMITATIONS DO NOT APPLY TO THE FACINGS, PROVIDED THAT THE FACING IS INSTALLED IN SUBSTANTIAL CONTACT WITH THE UNEXPOSED SURFACE OF THE CEILING, FLOOR OR WALL FINISH.

PLUMBING NOTES

PLUMBING FIXTURES:

WATER CLOSET = 1.6 GALLONS PER FLUSH MAX.

SHOWERHEAD = 2.5 GPM MAX.

LAVATORY FAUCETS = 2.2 GPM MAX.

SINK FAUCETS = 2.2. GPM MAX.

WATER USAGE LABELS SHALL BE LEFT ON PLUMBING FIXTURES UNTIL FINAL INSPECTION HAS BEEN DONE SO THAT PROOF OF WATER USAGE COMPLIANCE CAN BE VERIFIED BY THE BUILDING DEPARTMENT.

SHOWERS AND TUB-SHOWER COMBINATIONS SHALL BE PROVIDED WITH INDIVIDUAL CONTROLS VALVES OF THE PRESSURE BALANCE OR THE THERMOSTATIC MIXING VALVE TYPE. HANDLE POSITION STOPS SHALL BE PROVIDED ON SUCH VALVES AND SHALL BE ADJUSTED PER MANUFACTURER'S INSTRUCTIONS TO DELIVER A MAXIMUM MIXED WATER SETTING OF 120 DEG. F. THE WATER HEATER THERMOSTAT SHALL NOT BE CONSIDERED A SUITABLE CONTROL FOR MEETING THIS PROVISION.

WATER HEATER SHALL BE PROVIDED WITH A TEMPERATURE AND PRESSURE RELIEF VALVE HAVING A FULL-SIZED DRAIN OF GALVANIZED STEEL OR HARD DRAWN COPPER TO THE OUTSIDE OF THE BUILDING WITH THE END OF THE PIPE NOT MORE THAN 2 FT. OR LESS THAN 6 IN. ABOVE THE GRADE, POINTING DOWNWARD.

PROVIDE COMBUSTION AIR VENTS (WITH SCREEN AND BACK DAMPER) FOR ANY APPLIANCE WITH OPEN FLAME PROVIDE INDIVIDUAL SHUT-OFF VALVE FOR AT MAXIMUM 3 FEET FROM EVERY GAS APPLIANCE

UNDERGROUND FERROUS GAS PIPING SHALL BE ELECTRICALLY ISOLATED FROM TO REST OF THE GAS SYSTEM WITH LISTED ISOLATION FITTINGS INSTALLED A MINIMUM OF 6 IN. ABOVE GRADE.

ALL EXTERIOR HOSE BIBS TO HAVE NON-REMOVABLE BACKFLOW PREVENTION DEVICES.

PROVIDE AN ACCESS DOOR, 18" x 24" MINIMUM, WITHIN 20 FT. OF THE PLUMBING CLEANOUT.

ALL DISHWASHER WASTE LINES SHALL BE PROVIDED WITH AN APPROVED AIRGAP SEPARATION DEVICE.

PROVIDE MIN. 30 INCH WIDE SPACE AT WATER CLOSET, EXTENDING AT LEAST 30 INCHES IN FRONT.

NO GAS PIPING SHALL BE INSTALLED IN OR ON THE GROUND.

UNDER ANY BUILDING OR STRUCTURE. ALL EXPOSED GAS PIPING SHALL BE KEPT AT LEAST 6 IN. ABOVE GRADE OR STRUCTURE.

INSTALLATION INSTRUCTIONS FOR ALL LISTED EQUIPMENT SHALL BE PROVIDED TO THE FIELD INSPECTOR AT TIME OF INSPECTION.

PROJECT DETAILS

WINDOWS:	ANDERSEN 400 SERIES 10' CONC WALL
FOUNDATION:	
EXTERIOR WALLS:	2x6
GARAGE WALLS:	2x4
INTERIOR WALLS:	2x4
FIRST FLOOR:	10'-1 1/8"
SECOND FLOOR:	9'-1 1/8"
BASEMENT:	10'-0"

CUSTOM HOME DESIGNS, LLC
2841 S. 150 E.
COLUMBIA CITY, IN 46725
(260) 244-5851
WWW.CHD-LLC.COM

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GENERAL NOTES

PLAN #2012

DRAWN BY: BG
PROJECT: 2012
PRINT DATE:
10/18/2021
FINAL: MAR. 20, 2020
SCALE: 1/4" = 1'-0"

A-9

PROJECT DETAILS


WINDOWS:	ANDERSEN 400 SERIES
FOUNDATION:	10" CONC. WALL
EXTERIOR WALLS:	2x6
GARAGE WALLS:	2x4
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**1ST FLOOR ELECTRICAL
 PLAN #2012**

DRAWN BY: BG
 PROJECT: 2012
 PRINT DATE:
 10/18/2021
 FINAL: MAR. 20, 2020
 SCALE: 1/4" = 1'-0"



ELECTRICAL LEGEND		
COUNT	SYMBOL	ELECTRICAL
1		200 AMP DISCONNECT
1		200 AMP PANEL
2		BAR LIGHT 24"
2		BAR LIGHT 60"
91		CAN LIGHT 6"
2		CAN LIGHT 6" WET LOCATION
3		CEILING FAN
3		EXHAUST FAN
1		EXHAUST FAN LIGHT
12		FLOURESCENT LIGHT 2 x 4
5		LIGHT
1		METER
33		OUTLET
3		OUTLET 220v
1		OUTLET 60
5		OUTLET GARAGE DOOR

ELECTRICAL LEGEND		
COUNT	SYMBOL	ELECTRICAL
38		OUTLET GFI
6		OUTLET WP
9		SMOKE DETECTOR
26		SWITCH
19		SWITCH 3 WAY
3		SWITCH 4 WAY
1		TO 2ND FLR
1		TO B8MT
1		wall mount savy
3		LAN connection
3		cable tv outlet
3		outlet double
3		telephone
2		OUTLET Attic

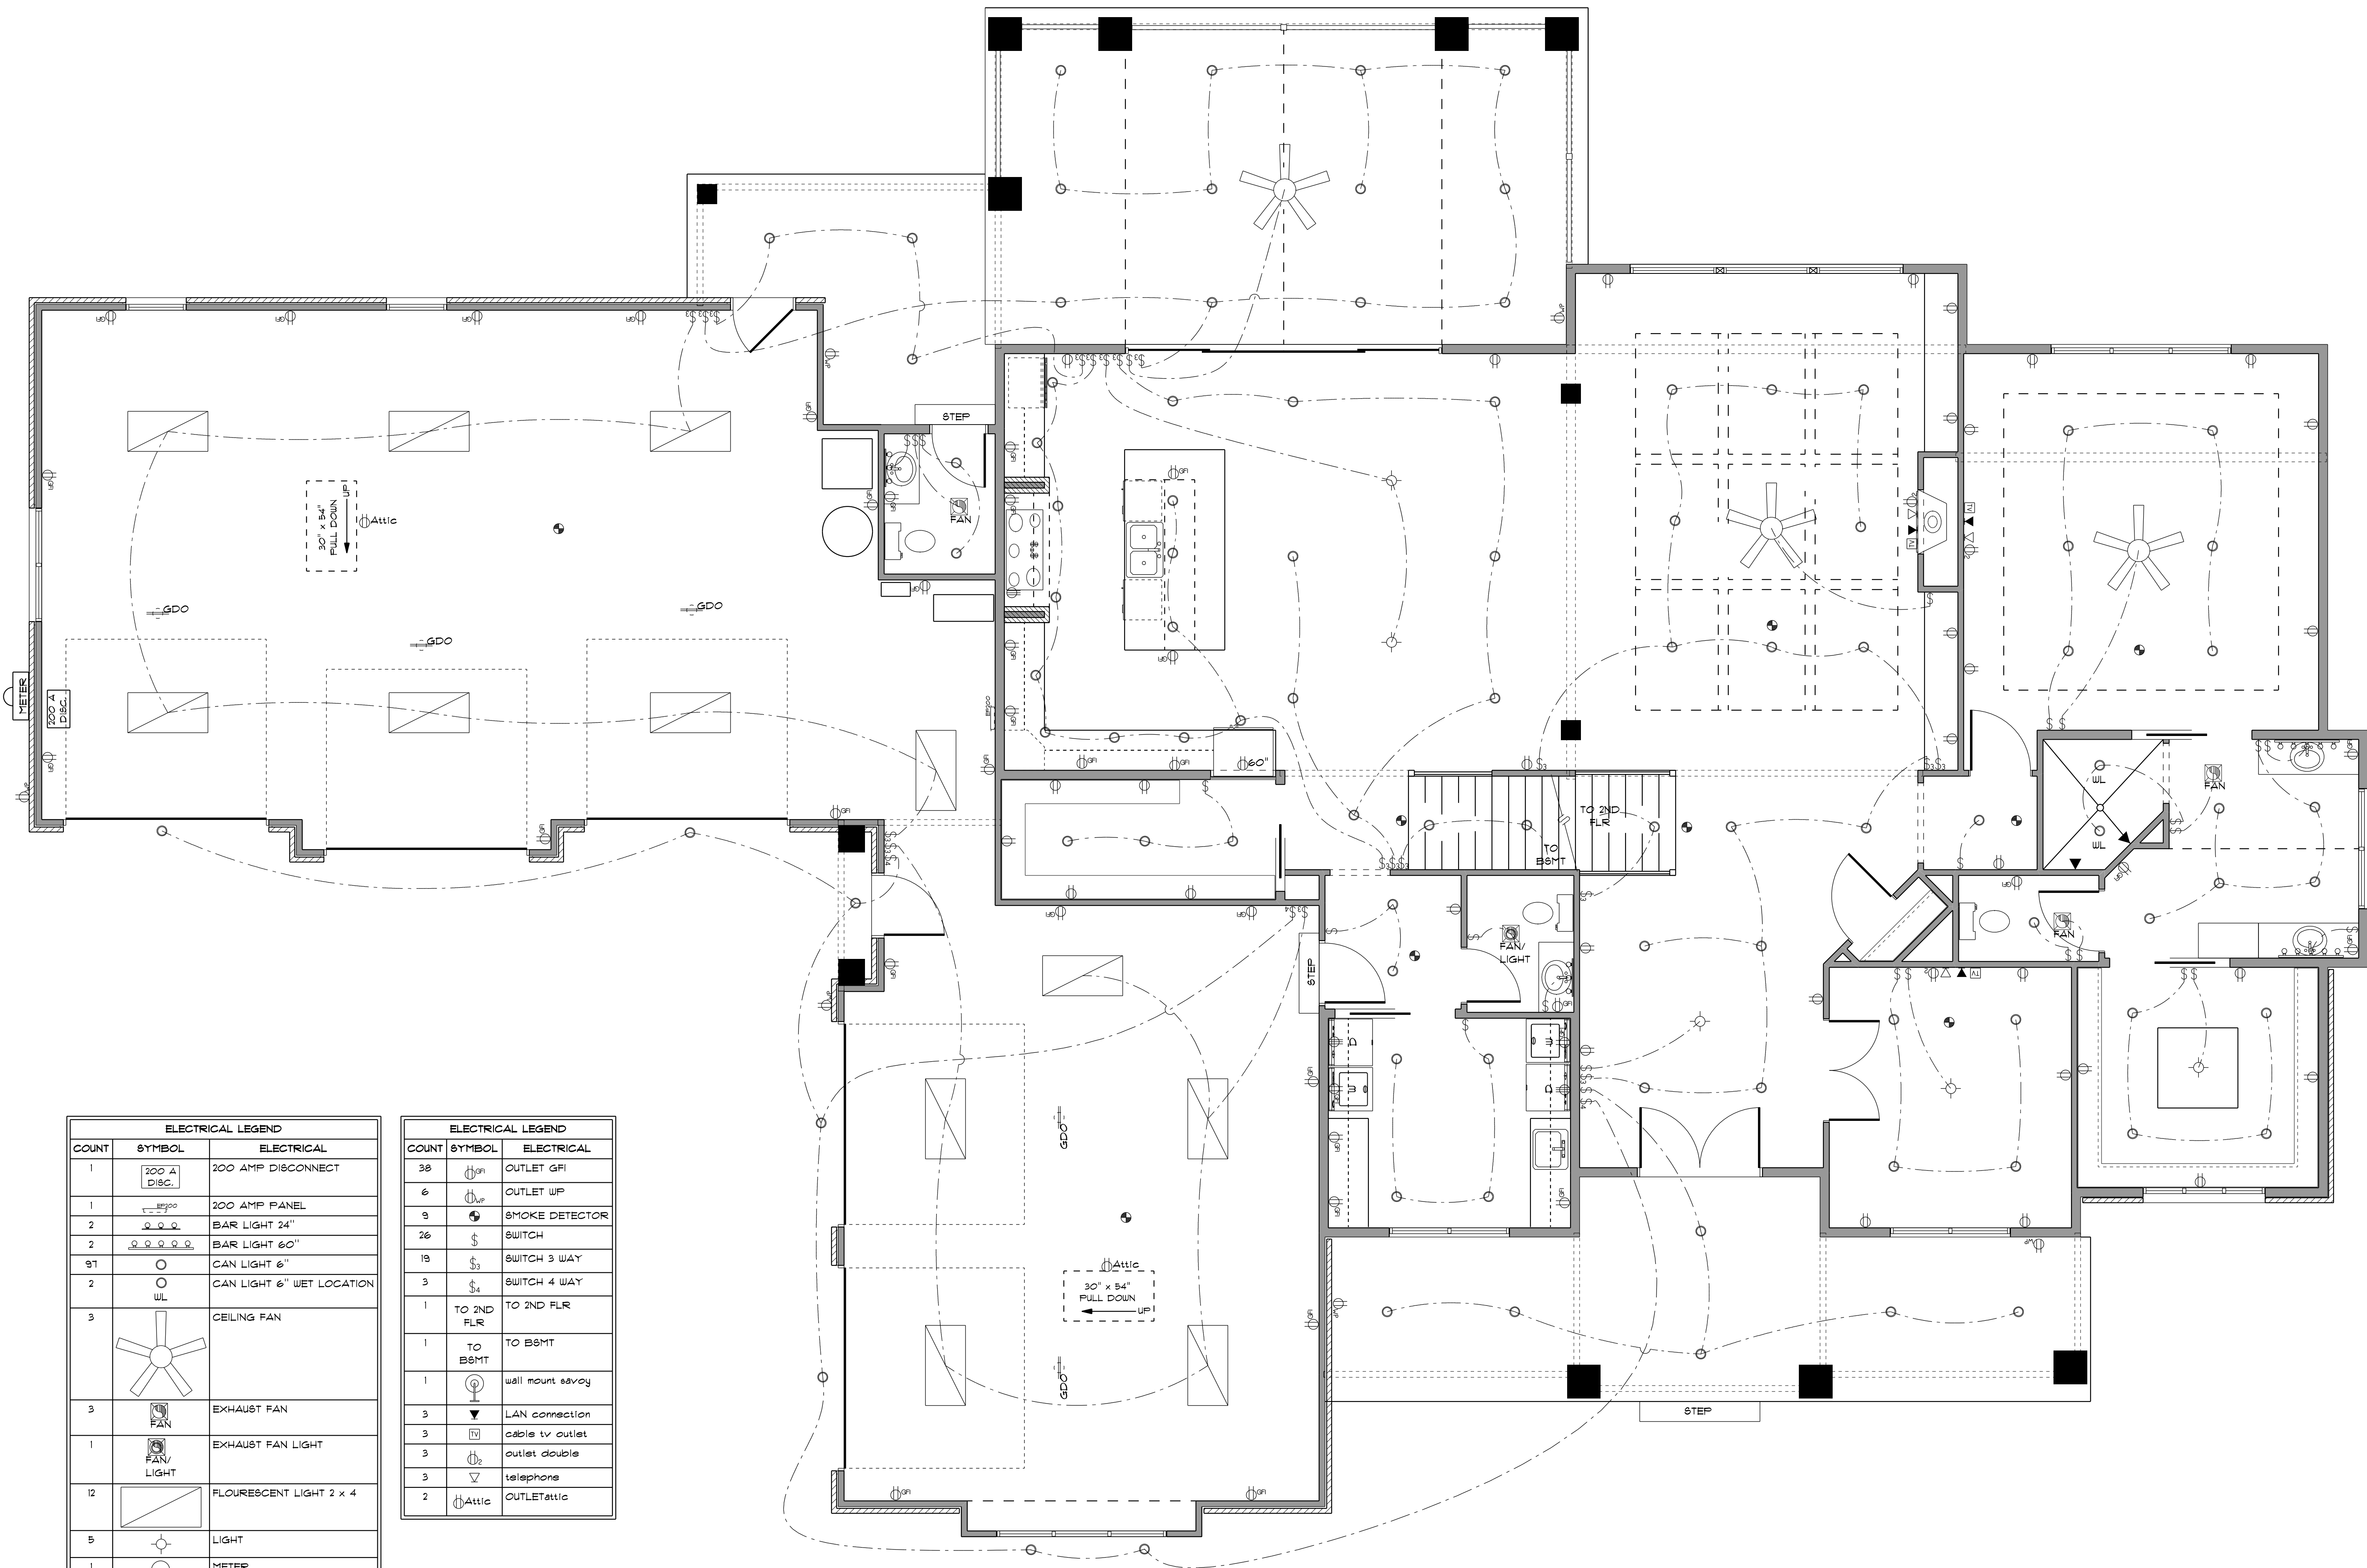FIRST FLOOR ELECTRIC PLAN
 SCALE: 1/4" = 1'-0"

PROJECT DETAILS


WINDOWS:	ANDERSEN 400 SERIES
FOUNDATION:	10" CONC. WALL
EXTERIOR WALLS:	2x6
GARAGE WALLS:	2x4
INTERIOR WALLS:	2x4
FIRST FLOOR:	10'-1 1/8"
SECOND FLOOR:	9'-1 1/8"
BASEMENT:	10'-0"

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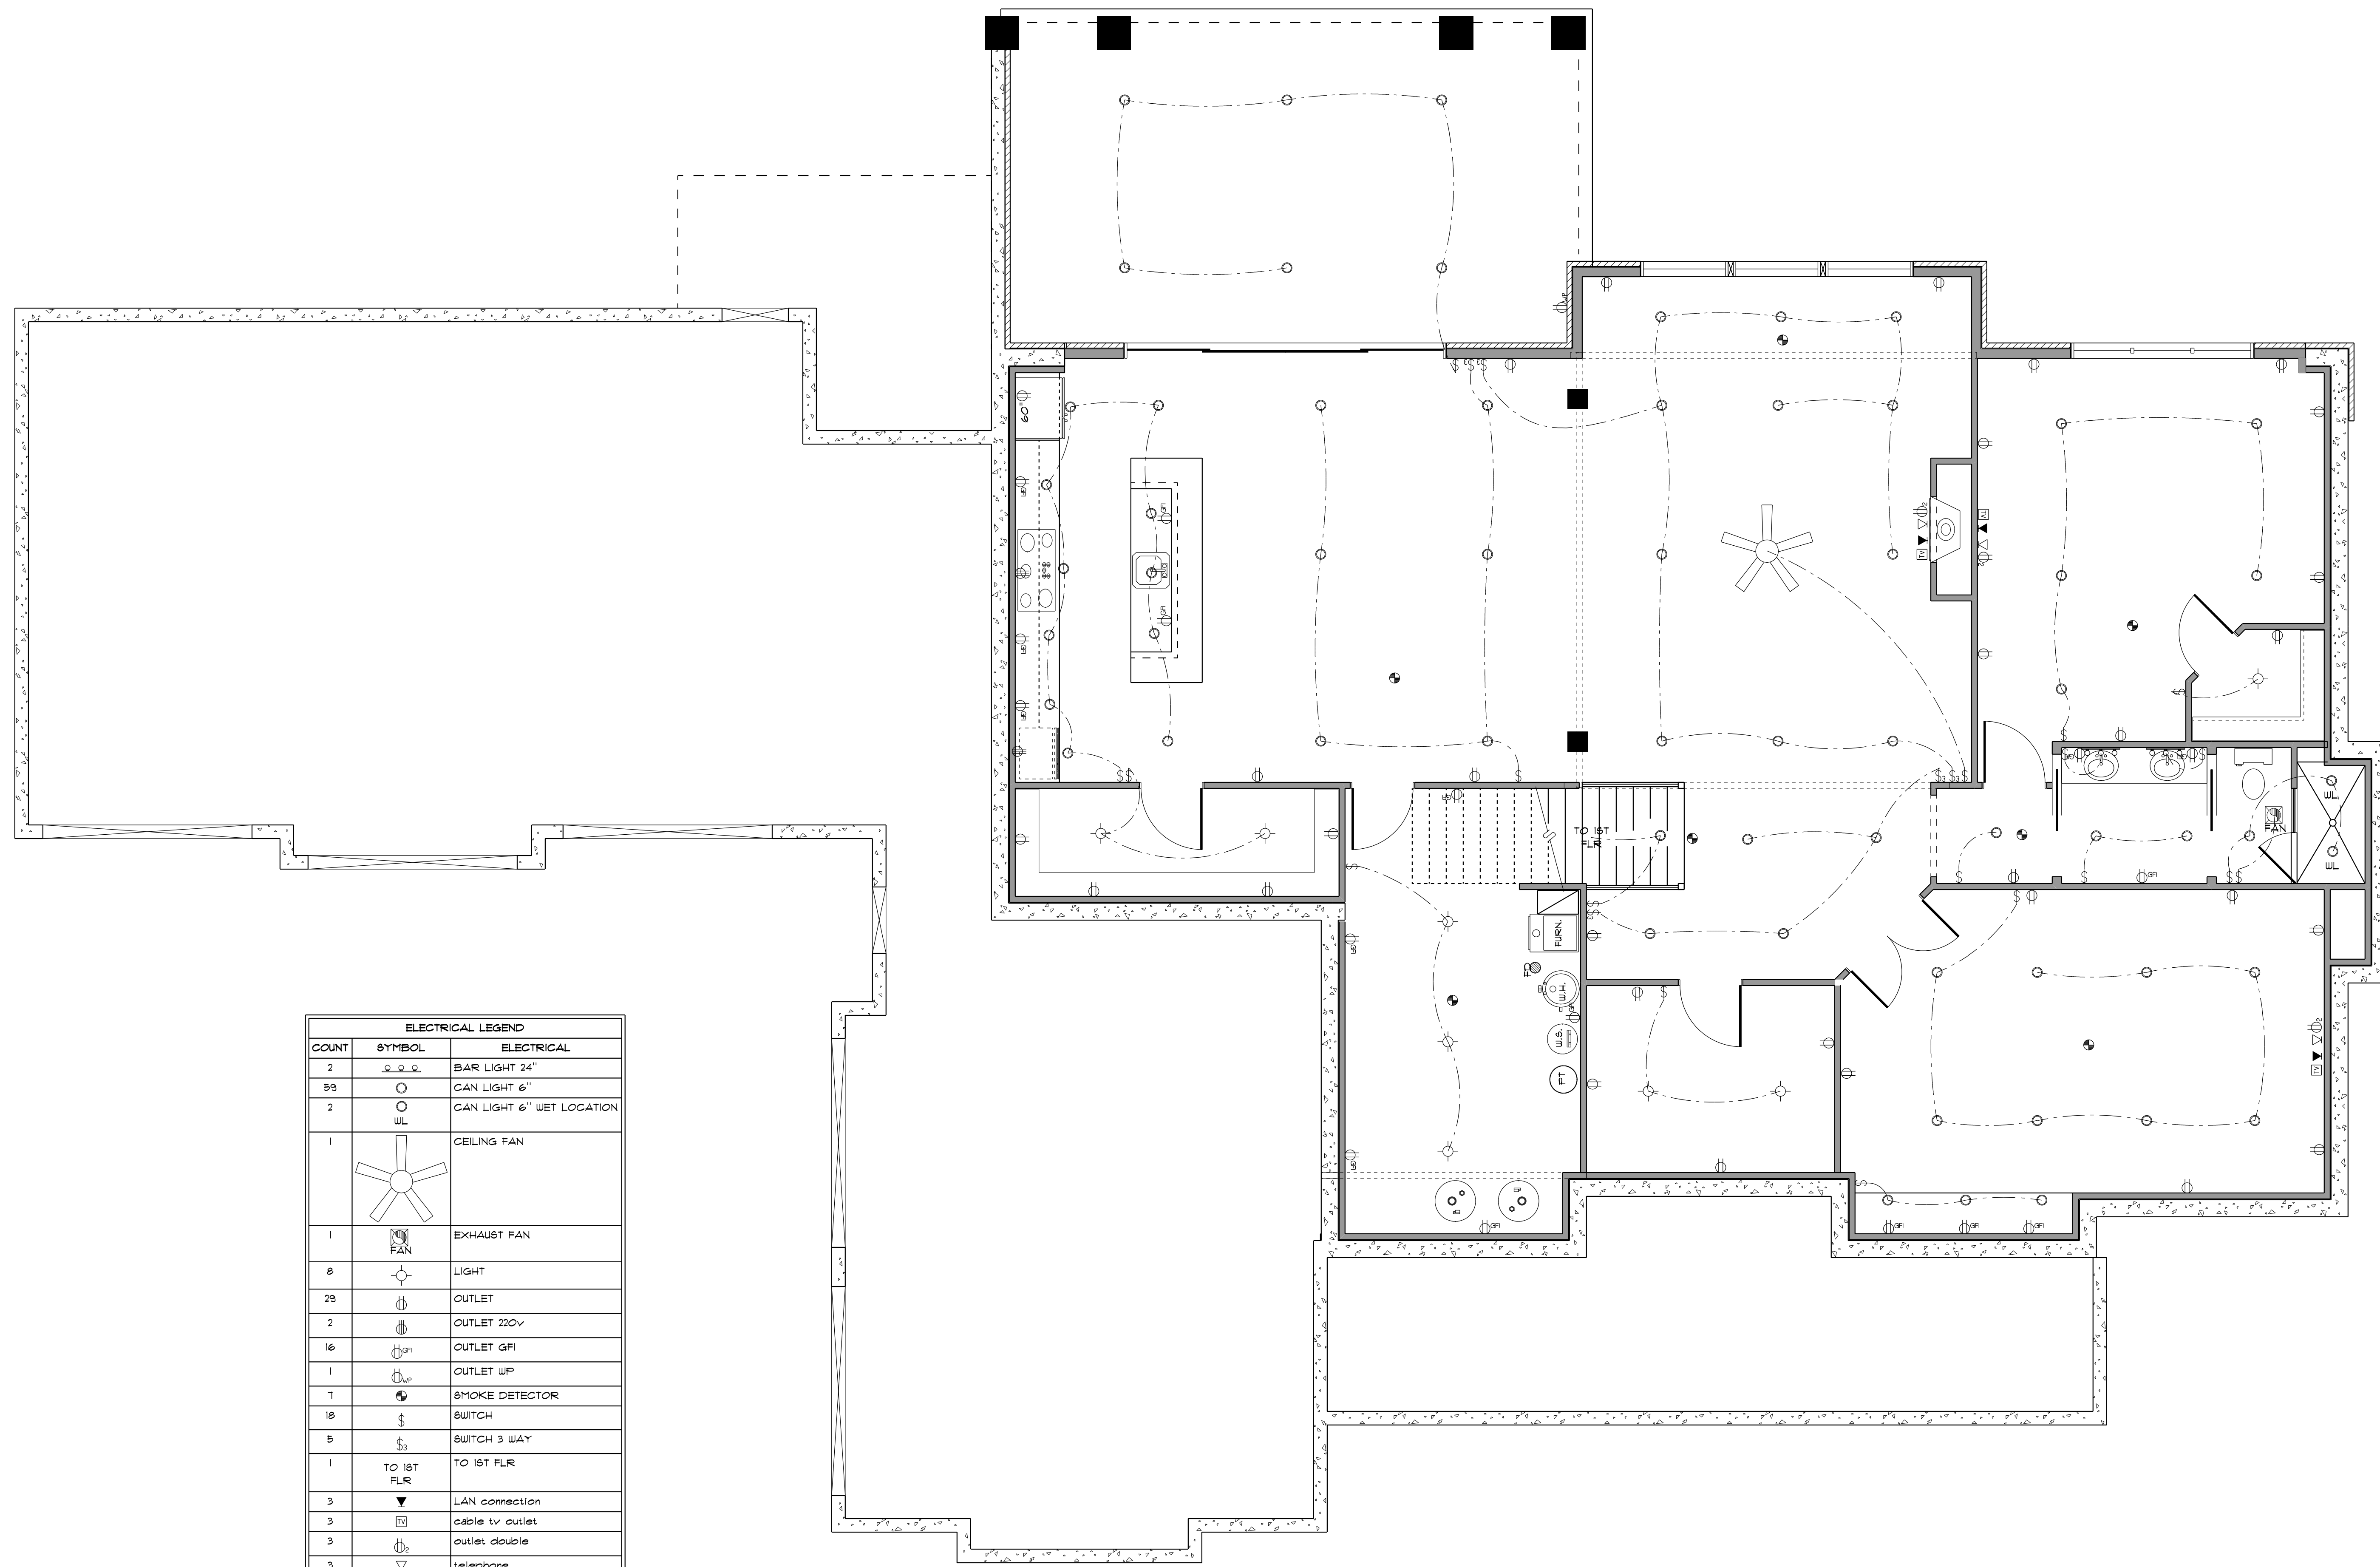
**2ND FLOOR ELECTRICAL
 PLAN #2012**

DRAWN BY: BG
 PROJECT: 2012
 PRINT DATE:
 10/18/2021
 FINAL: MAR. 20, 2020
 SCALE: 1/4" = 1'-0"



ELECTRICAL LEGEND		
COUNT	SYMBOL	ELECTRICAL
3	⊖	BAR LIGHT 24"
1	⊖	BAR LIGHT 60"
26	○	CAN LIGHT 6"
1		CEILING FAN
3		EXHAUST FAN
55	⊕	OUTLET
13	⊕	LIGHT
5	⊕GFI	OUTLET GFI
9	⊕	SMOKE DETECTOR
28	⊕	SWITCH
6	⊕	LAN connection
6	⊕	cable tv outlet
6	⊕	outlet double
6	⊕	telephone
1	⊕3	SWITCH 3 WAY
3	⊕4	SWITCH 4 WAY
1	TO BSMT	TO BSMT

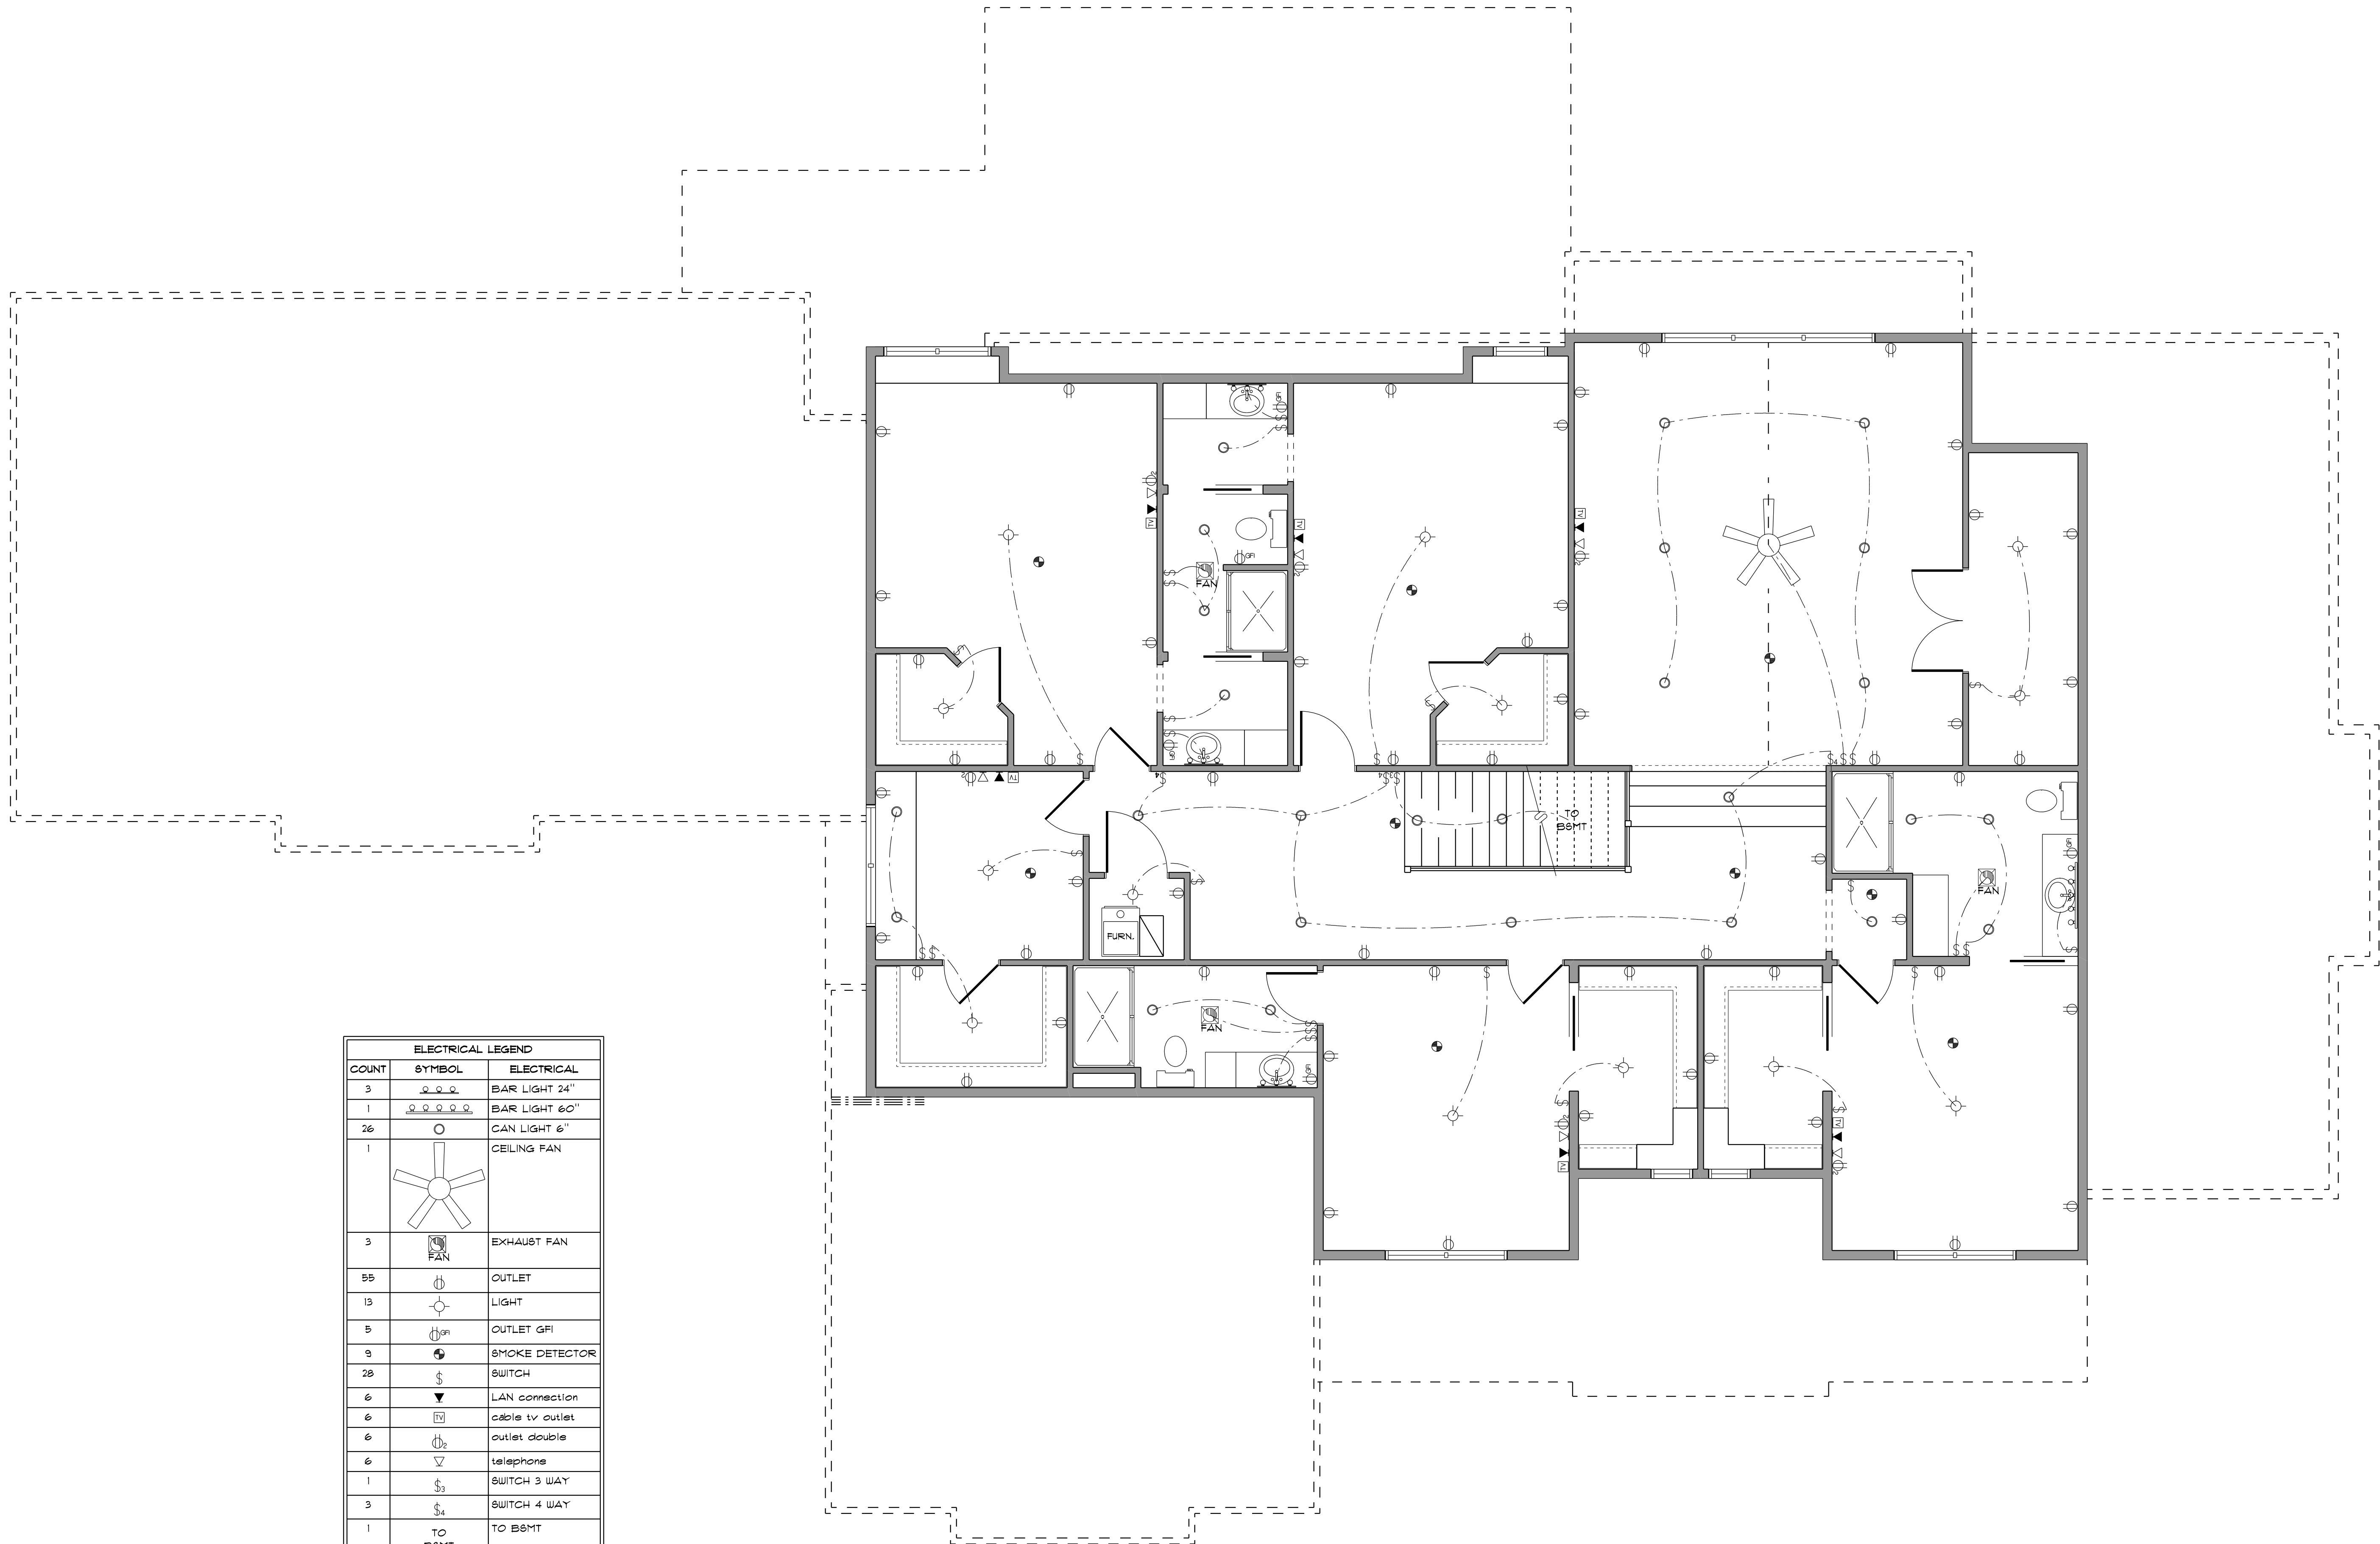SECOND FLOOR ELECTRIC PLAN
 SCALE: 1/4" = 1'-0"



ELECTRICAL LEGEND		
COUNT	SYMBOL	ELECTRICAL
2	⊙ ⊙ ⊙	BAR LIGHT 24"
59	○	CAN LIGHT 6"
2	○	CAN LIGHT 6" WET LOCATION
1		CEILING FAN
1		EXHAUST FAN
8	⊕	LIGHT
29	⊕	OUTLET
2	⊕	OUTLET 220V
16	⊕	OUTLET GFI
1	⊕	OUTLET WP
7	⊕	SMOKE DETECTOR
18	⊕	SWITCH
5	⊕	SWITCH 3 WAY
1	TO 1ST FLR	TO 1ST FLR
3	▼	LAN connection
3	⊕	cable tv outlet
3	⊕	outlet double
3	⊕	telephone
1	⊕	OUTLET 60

BASEMENT ELECTRIC PLAN
SCALE: 1/4" = 1'-0"

PROJECT DETAILS	
WINDOWS:	ANDERSEN 400 SERIES
FOUNDATION:	10" CONC. WALL
EXTERIOR WALLS:	2x6
GARAGE WALLS:	2x4
INTERIOR WALLS:	2x4
FIRST FLOOR:	10'-1 1/8"
SECOND FLOOR:	9'-1 1/8"
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BASEMENT ELECTRICAL
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